RAIN WATER HARVESTING SYSTEM PICO BRANCH LIBRARY 2201 PICO BLVD. SANTA MONICA, CA 90404

GENERAL NOTES

RAIN WATER HARVESTING SYSTEM GENERAL NOTES

- 1. WHEN APPLICABLE, WORK SHOWN HEREON SHALL BE DONE IN ACCORDANCE WITH THE "STANDARD SPECIFICATIONS FOR PUBLIC WORKS CONSTRUCTION," LATEST EDITION AND SUPPLEMENTS, THE UNIFORM BUILDING CODE (EXCAVATION AND GRADING), AND CITY OF SANTA MONICA ORDINANCES AS APPLICABLE
- 2. RAIN WATER HARVESTING SYSTEM PLANS ARE BASED UPON THE FOLLOWING: A. ARCHITECTURAL PLANS PROVIDED BY KONING EIZENBERG ARCHITECTURE, DATED
- B. GRADING AND DRAINAGE PLANS PROVIDED BY KPFF CONSULTING ENGINEERS, DATED FEBRUARY 21, 2012.
- C. PLUMBING PLANS PROVIDED BY GLUMAC, DATED FEBRUARY 21, 2012 D. ELECTRICAL PLANS PROVIDED BY GLUMAC, DATED FEBRUARY 21, 2012. 3. EXISTING TOPOGRAPHY SHOWN HEREON WAS PROVIDED BY OWNER
- 4. THE CONTRACTOR SHALL ASSUME SOLE AND COMPLETE RESPONSIBILITY FOR THE JOB SITE CONDITIONS, INCLUDING SAFETY OF ALL PERSONS AND PROPERTY DURING THE COURSE OF CONSTRUCTION OF THIS PROJECT. THIS REQUIREMENT SHALL APPLY CONTINUOUSLY, AND SHALL NOT BE LIMITED TO NORMAL WORKING
- 5. PRIOR TO COMMENCING CONSTRUCTION, THE CONTRACTOR SHALL VERIFY ALL EXISTING CONDITIONS FOR GRADING, DRAINAGE AND UNDERGROUND UTILITIES INCLUDING LOCATION AND ELEVATION OF EXISTING UNDERGROUND UTILITIES AT CROSSINGS WITH PROPOSED UNDERGROUND UTILITIES. IF CONDITIONS DIFFER FROM THOSE SHOWN ON THE PLANS, THE CONTRACTOR SHALL NOTIFY THE ENGINEER AND SHALL NOT BEGIN CONSTRUCTION UNTIL THE CHANGED CONDITIONS HAVE BEEN EVALUATED
- 6. THE ENGINEER PREPARING THESE PLANS WILL NOT BE RESPONSIBLE FOR, OR LIABLE FOR, UNAUTHORIZED CHANGES TO OR USES OF THESE PLANS. ALL CHANGES TO THE PLANS MUST BE IN WRITING AND MUST BE APPROVED BY THE PREPARER OF THESE PLANS
- 7. NOTES AND DETAILS ON DRAWINGS SHALL TAKE PRECEDENCE OVER GENERAL NOTES AND TYPICAL DETAILS. WHERE NO ARE GIVEN. CONSTRUCTION SHALL BE
- 8. THE EXISTENCE, LOCATION AND CHARACTERISTICS OF UNDERGROUND UTILITY INFORMATION SHOWN ON THESE PLANS HAVE BEEN OBTAINED FROM A REVIEW OF AVAILABLE RECORD DATA. NO REPRESENTATION IS MADE AS TO THE ACCURACY OR COMPLETENESS OF SAID UTILITY INFORMATION. THE CONTRACTOR SHALL TAKE PRECAUTIONARY MEASURES TO PROTECT THE UTILITY LINES SHOWN AND ANY OTHER LINES NOT OF RECORD OR NOT SHOWN ON THESE PLANS
- 9. IF AT ANY TIME DURING GRADING OPERATIONS, ANY UNFAVORABLE GEOLOGICAL CONDITIONS ARE ENCOUNTERED, GRADING IN THAT AREA WILL STOP UNTIL APPROVED CORRECTIVE MEASURES ARE OBTAINED
- 10. ALL DEBRIS AND FOREIGN MATERIAL SHALL BE REMOVED FROM THE SITE AND DISPOSED OF AT APPROVED DISPOSAL SITES. THE CONTRACTOR SHALL OBTAIN NECESSARY PERMITS FOR THE TRANSPORTATION OF MATERIAL TO AND FROM THE
- 11. ALL FILL SOILS OR SOILS DISTURBED OR OVEREXCAVATED DURING CONSTRUCTION SHALL BE COMPACTED PER THE REQUIREMENTS OF THE SOILS REPORT BUT NOT LESS THAN 90% MAXIMUM DENSITY AS DETERMINED BY A.S.T.M. SOIL COMPACTION
- 12. THE CONTRACTOR SHALL OBTAIN AN O.S.H.A. PERMIT FROM THE CALIFORNIA DIVISION OF INDUSTRIAL SAFETY PRIOR TO THE CONSTRUCTION OF TRENCHES OR EXCAVATIONS WHICH ARE FIVE FEET OR DEEPER
- 13. ALL STORM DRAIN AND SANITARY SEWER PIPE, FITTINGS AND JOINTS SHALL BE POLYVINYL CHLORIDE SDR 35 OR SCH 80 IN ACCORDANCE WITH SECTION 207-17 OF THE STANDARD SPECIFICATIONS, UNLESS OTHERWISE NOTED
- 14. ALL WATER LINES SHALL BE POLYVINYL CHLORIDE CLASS 150 AND SHALL MEET THE REQUIREMENTS OF AWWA C900 PVC PRESSURE PIPE, UNLESS OTHERWISE
- 15. THRUST BLOCKS SHALL BE INSTALLED AT WATERLINE HORIZONTAL AND VERTICAL BENDS, TEES, CAPPED ENDS AND REDUCERS ACCORDING TO THE STANDARD PLAN METRIC 508-1 THRUST BLOCKS FOR PLASTIC PIPE.
- 16. THE CONTRACTOR SHALL REPLACE ALL EXISTING IMPROVEMENTS DAMAGED DURING CONSTRUCTION TO MATCH EXISTING, INCLUDING PERMANENT TRENCH RESURFACING 17. CONTRACTOR TO BE AWARE OF ALL OVERHEAD LINES AT ALL TIMES. SO AS NOT TO DISTURB THEM.
- 18. WATER SHALL BE PROVIDED ONSITE AND USED TO CONTROL DUST DURING
- CONSTRUCTION OPERATIONS 19. CONTRACTOR SHALL OBTAIN ANY NECESSARY PERMITS FROM THE APPROPRIATE
- LOCAL REGULATOR FOR ALL WORK WITHIN THE PUBLIC RIGHT-OF-WAY. 20. CONTRACTOR SHALL OBTAIN ALL REQUIRED PERMITS, INCLUDING NPDES, FROM

THE APPROPRIATE JURISDICTIONAL AGENCIES FOR DISCHARGE OF GROUNDWATER

- THAT MAY BE NECESSARY TO ACCOMPLISH EXCAVATIONS SHOWN ON THESE PLANS. 21. THE CONTRACTOR SHALL PROVIDE AND PAY FOR ALL CONSTRUCTION SURVEYING THAT MAY BE REQUIRED. ALL CONSTRUCTION STAKING, AS REQUIRED, SHALL BE PERFORMED BY A LICENSED LAND SURVEYOR. THE WORK SHALL BE CERTIFIED IN WRITING AS TO LINE AND GRADE PER APPROVED PLANS TO BE SUBMITTED TO THE ENGINEER FOR APPROVAL
- 22. THE DRAWINGS AND SPECIFICATIONS BY THE ENGINEER REPRESENT THE COMPLETED CONSTRUCTION. ALL BRACING, TEMPORARY SUPPORTS, SHORING, ETC., IS THE SOLE RESPONSIBILITY OF THE CONTRACTOR. OBSERVATION VISITS TO THE JOB SITE BY THE ENGINEER SHALL NOT INCLUDE INSPECTION OF CONSTRUCTION METHODS AND SAFETY CONDITIONS AT THE WORK SITE. THESE VISITS SHALL NOT BE CONSTRUED AS CONTINUOUS AND DETAILED INSPECTIONS
- 23. ALL PIPING ABOVE-GRADE FOR THE PUMPS AND EQUIPMENT. AND PIPING MANIFOLDS, SHALL BE STRUCTURALLY SUPPORTED BY ADEQUATE PIPE SUPPORTS OR HANGERS, PER LOCAL CODES AND ORDINANCES
- 24. ALL PIPE AND CONDUIT TRENCH BACKFILL, MATERIAL, AND COMPACTION SHALL CONFORM TO LOCAL STANDARDS. BORING OR TUNNELING UNDER EXISTING IMPROVEMENTS IS NOT ALLOWED. NO OPEN EXCAVATIONS SHALL BE ALLOWED OVERNIGHT. BEFORE THE END OF EVERY WORK DAY, THE CONTRACTOR SHALL BACKFILL OR PLATE OVER ALL OPEN EXCAVATIONS, TO THE SATISFACTION AND APPROVAL OF THE OWNER AND/OR ENGINEER.
- 25. ALL PIPING SHALL BE COMPLETELY CONCEALED. WHEREVER POSSIBLE. ANY EXPOSED PVC PIPE AND FITTINGS SHALL BE ULTRAVIOLET—RESISTANT (UVR—PVC) OR SHALL BE PAINTED, SUBJECT TO APPROVAL OF THE ENGINEER.
- 26. ALL PUMPS, VAULTS, VALVE BOXES, OTHER STRUCTURES, PIPELINES, ETC., MUST BE INSTALLED OUTSIDE OF THE UTILITY EASEMENTS, AND OUTSIDE OF ANY OTHER PROHIBITED EASEMENTS AND AREAS. IT IS THE RESPONSIBILITY OF THE CONTRACTOR TO BECOME KNOWLEDGEABLE OF, AND TO COMPLETELY UNDERSTAND, THESE EASEMENTS AND AREAS, AND TO AVOID CONSTRUCTION THEREIN; AS POSSIBLE. FOR THE SAKE OF CLARITY IN THESE DESIGN PLANS, PUMPS, VAULTS, VALVE BOXES, PIPELINES, ETC., MAY NOT ALL BE SHOWN OUTSIDE OF THE EASEMENTS. AS SUCH DEPICTIONS ARE SCHEMATIC ONLY.
- 27. ALL PIPING LOCATIONS SHOWN ON THESE DESIGN PLANS ARE SCHEMATIC ONLY, AND ARE SUBJECT TO MINOR RELOCATION(S). PIPELINE CIRCUITRY/LAYOUT (BRANCHING), HOWEVER, SHALL BE EXACTLY AS PER THE PLANS. PIPELINES SHOULD BE INSTALLED IN THE MOST DIRECT ROUTE(S) POSSIBLE: FROM INTAKES TO PUMPS, AND FROM PUMPS TO DISCHARGE POINTS. A COPY OF AS-BUILT CONDITIONS SHALL BE MAINTAINED ON THE JOB SITE, AND SHALL BE DELIVERED TO THE OWNER AND TO THE ENGINEER WHENEVER REQUESTED, AND WHEN CONSTRUCTION IS COMPLETED; FOR APPROVAL.

- 28. WRITTEN DIMENSIONS SHALL TAKE PRECEDENCE OVER SCALED DIMENSIONS. 29. PIPING SHALL BE INSTALLED IN TRENCHES IN THE MOST UNIFORM GRADE AS IS POSSIBLE, AND SHALL HAVE NO LOCAL HIGH OR LOW POINTS.
- 30. HORIZONTAL PIPE RUNS SHALL HAVE 18" MINIMUM COVER WHEN UNDER PAVED SURFACES AND 12" MINIMUM COVER OTHERWISE
- 31. THE CONTRACTOR SHALL NOTIFY UNDERGROUND SERVICE ALERT, AT (800) 227-2600, AT LEAST TWO WORKING DAYS BEFORE ANY DIGGING. NOTE THAT THE USA CENTER ONLY NOTIFIES THOSE UTILITIES BELONGING TO THE CENTER. THERE MAY BE OTHER UTILITIES PRESENT AT THE WORK SITE. THE CENTER WILL INFORM YOU OF WHOM THEY WILL NOTIFY
- 32. ALL WORK SPECIFIED HEREIN SHALL, AT ALL TIMES, COMPLY WITH ALL APPLICABLE CURRENT BUILDING CODES, PLUMBING CODES, ELECTRICAL CODES, ADA REQUIREMENTS, AND WITH ALL LOCAL REGULATIONS AND ORDINANCES. ALL WORK SHALL COMPLY WITH THE REQUIREMENTS OF THE CURRENT CALIFORNIA AND UNIFORM BUILDING CODE (CBC, UBC) AS TO DESIGN AND CONSTRUCTION, TITLE 24 PERTAINING TO "DISABLED ACCESS REGULATIONS."
- 33. ANY INCIDENTAL INSTALLATION PROCEDURE, MATERIAL, OR EQUIPMENT NOT MENTIONED IN THESE CONSTRUCTION DOCUMENTS, INCLUDING THE PLANS AND SPECIFICATIONS, WHICH MAY BE NECESSARY FOR COMPLETION AND SATISFACTORY OPERATION OF THE DESIGN OR SYSTEM, SHALL BE FURNISHED AND INSTALLED, AS BASED ON THE INDUSTRY STANDARDS; AS THOUGH SHOWN OR PROVIDED FOR IN THE CONSTRUCTION DOCUMENTS
- 34. INTERPRETATION OF THE DESIGN DOCUMENTS, INCLUDING PLANS AND SPECIFICATIONS, SHALL BE MADE BY THE AUTHOR, ARCHITECT, OR ENGINEER OF RECORD OF THE RESPECTIVE DOCUMENT. SUCH INTERPRETATION(S) SHALL BE THE CONTRACTOR PRIOR TO SUBMITTING FORMAL BIDS. ALL CLARIFICATIONS SHALL BE PREPARED IN WRITING BY THE ARCHITECT OR ENGINEER OF RECORD PRIOR TO BIDDING. THE CONTRACTOR SHALL ACCEPT THE INTERPRETATION(S) OF THE ARCHITECT OR ENGINEER OF RECORD AS THE CORRECT AND FINAL
- INTERPRETATION(S). 35. ALL OMISSIONS, DISCREPANCIES, ERRORS, AND CONFLICTS IN THE DRAWINGS SHALL BE BROUGHT TO THE ATTENTION OF THE ENGINEER, THE OWNER, AND ITS DESIGNATED REPRESENTATIVE(S) INTENT BEFORE PROCEEDING WITH WORK
- 36. THESE CONSTRUCTION DOCUMENTS, INCLUDING ALL PLANS, NOTES, DETAILS, AND SPECIFICATIONS, ARE INTENDED TO FACILITATE THE INSTALLATION CONTRACTOR, BY PROVIDING GENERAL GUIDELINES OF THE DESIGN INTENT. IT IS THE GOAL OF THE DOCUMENTS THAT THE CONSTRUCTION WORK BE COMPLETED WITHOUT CHANGE ORDERS. ALL QUANTITIES SHOWN IN THE DOCUMENTS ARE ESTIMATES ONLY, AND ARE NOT GUARANTEED. THE CONTRACTOR SHALL SUPPLY ALL MATERIALS, LABOR. AND EQUIPMENT IN ORDER TO FULFILL THE DESIGN INTENT.
- 37. THE CONTRACTOR SHALL PROVIDE AND INSTALL TEMPORARY PROTECTIVE FENCING FOR OPEN TRENCH EXCAVATION AND AS REQUIRED IN WORK AREAS FOR PEDESTRIAN AND VEHICULAR SAFETY, TO SECURE EQUIPMENT AND PERSONNEL FROM PUBLIC AT ALL TIMES FOR JOBSITE SECURITY. NEW OR USED MATERIAL MAY BE FURNISHED.
- 38. CONTRACTOR SHALL PROVIDE AND INSTALL SIGNAGE TO PROVIDE DIRECTIONAL, IDENTIFICATION, AND CONTACT INFORMATION TO CONSTRUCTION PERSONNEL AND PUBLIC.
- 39. EPD CONSULTANTS. INC ASSUMES NO LIABILITY. REAL OR ALLEGED. REGARDING THE ACCURACY OF THE TOPOGRAPHIC INFORMATION SHOWN.
- 40. CONTRACTOR SHALL BE APPROPRIATELY LICENSED WITH THE STATE OF CALIFORNIA TO PERFORM THE WORK OUTLINED IN THESE PLANS. NO WORK IS TO PROCEED WITHOUT OBTAINING A VALID PERMIT FROM THE LOCAL DEPARTMENT OF ENVIRONMENTAL HEALTH.
- 41. THE CONTRACTOR SHALL DEFEND, INDEMNIFY AND HOLD THE OWNER AND THE ENGINEER HARMLESS FROM ALL LIABILITY, REAL OR ALLEGED, IN CONNECTION WITH THE PERFORMANCE OF WORK ON THE PROJECT; EXCEPT FOR LIABILITY ARISING FROM THE SOLE NEGLIGENCE OF THE OWNER OR THE ENGINEER.
- 42. SANITARY WASTEWATER AND PROCESS WASTEWATER SYSTEMS TO OBSERVE ALL SETBACKS REQUIRED BY THE CITY DEPARTMENT OF ENVIRONMENTAL HEALTH.
- 43. NO VEHICULAR TRAFFIC, CUTS OR FILLS TO OCCUR WITHIN THE BOUNDARY OF CONSTRUCTION FENCING, CONSTRUCTION FENCING TO REMAIN IN PLACE FOR THE DURATION OF CONSTRUCTION PROJECT. 44. ENGINEERS APPROVED SUBMITTALS PRIOR TO ORDERING RAIN WATER HARVESTING
- SYSTEM SHALL BE AS FOLLOWS: (a) SELECT FILL MATERIAL, (b) PIPING AND APPURTENANCES, (c) GRAVITY FLOW LINES FROM ALL PIPE CONNECTIONS AND TANKS TO INVERTS, (d) TANKS AND
- APPURTENANCES, (e) NOT USED, (f) TREATMENT SYSTEM & PUMPS, (q) CONTROL PANEL(S), (h) A WRITTEN REPORT OF THE HYDROSTATIC AND LEAKAGE TEST PROCEDURE AND RESULTS, (i) WATER TABLE ANALYSIS TO WAIVE TANK ANCHOR REQUIREMENT OR INSTALLATION OF CONCRETE DEADMEN ANCHORS. 45. ENGINEER REQUIRED INSPECTIONS: (a) SEE CONSTRUCTION NOTE (L) PER SHEET W-2. IF SYSTEM
- DESIGNER (EPD) DOES NOT OBSERVE THE CONSTRUCTION, ALL LIABILITY IS RELEASED TO THE INSTALLER, (b) PRIOR TO ORDERING THE RAIN WATER HARVESTING SYSTEM COMPONENTS, A PRE CONSTRUCTION MEETING SHALL TAKE PLACE AT THE JOBSITE TO DETERMINE FINAL ELEVATIONS AND LOCATIONS OF ALL RAIN WATER HARVESTING SYSTEM COMPONENTS.

RAIN WATER HARVESTING SYSTEM SPECIAL NOTES:

- 46. EXISTING UNDERGROUND UTILITIES: BEFORE STARTING ANY UNDERGROUND WORK, THE CONTRACTOR SHALL OBTAIN THE SERVICES OF A COMPANY CERTIFIED TO PERFORM UNDERGROUND SCANNING SERVICES ALONG THE SITE UTILITY TRENCH FOR THE PURPOSE OF ESTABLISHING THE LOCATION OF ALL EXISTING UNDERGROUND UTILITY LINES. APPROPRIATE DIGGING METHODS AND TOOLS SHALL BE UTILIZED TO AVOID DAMAGE TO THE EXISTING UTILITY LINES. IN THE EVENT THAT DURING THE UNDERGROUND WORK. THE CONTRACTOR WILL DAMAGE ANY OF EXISTING LINES. IT WILL BE HIS RESPONSIBILITY TO DO ALL NECESSARY REPAIR WORK REPAIR WORK AT HIS EXPENSES.
- 47. CROSSING UNDERGROUND UTILITIES: IN MOST CASES CROSSING AT EXISTING UNDERGROUND UTILITIES SHALL BE RUN UNDER THE EXISTING LINES. ACTION REQUIRED FOR UNFORESEEN CONDITIONS AND LINES NOT INDICATED ON PLANS SHALL BE VERIFIED WITH THE DISTRICT INSPECTOR AND THE ENGINEER.
- 48. THE EXISTING CONDITIONS ABOVE GROUND: STRUCTURES SUCH AS BUILDINGS, FENCES, CONCRETE PAVEMENT AND SLABS, EQUIPMENT SUPPORT PADS AND DRIVEWAY AS SHOWN ON THE PLANS ARE TAKEN FROM EXISTING RECORD DRAWINGS AND VERIFIED BY FIELD OBSERVATION. IT SHALL BE THE CONTRACTOR'S RESPONSIBILITY TO ACCURATELY LOCATE ANY ABOVE GROUND STRUCTURE THAT MAY INTERFERE WITH THE INSTALLATION OF THE WORK. ANY DAMAGE TO EXISTING STRUCTURES RESULTING FROM THIS WORK SHALL BE REPAIRED TO MATCH EXISTING AT NO ADDITIONAL COST TO THE PICO BRANCH LIBRARY.

- 49. PEDESTRIAN AND VEHICULAR PATH OF TRAVEL: CONTRACTOR TO LOCATE SITE PATH TRENCHES. CONTRACTOR TO USE STEEL PLATES OF SUFFICIENT WIDTH AND THICKNESS TO COVER THE TRENCH. FURTHERMORE, THE CONTRACTOR SHALL PROVIDE CHAIN LINK FENCING ON EACH SIDE OF THE PATH OF TRAVEL. THE CONTRACTOR SHALL COOPERATE WITH THE SCHOOL ADMINISTRATORS AND THE PICO BRANCH LIBRARY REPRESENTATIVES AT ALL TIMES TO MAINTAIN ACCESS TO THE SITE. WIDTH OF PATHS OF TRAVEL FOR PEDESTRIAN AND VEHICULAR TRAFFIC SHALL BE DETERMINED BY THE CONSTRUCTION MANAGER
- 50. SHORING REQUIREMENTS: ANY PROPOSED SHORING SHALL BE SUBMITTED FOR ENGINEERS APPROVAL PRIOR TO CONSTRUCTION AND SHALL COMPLY WITH ALL APPLICABLE REGULATIONS AND THE RECOMMENDATIONS OF THE PROJECT SOILS
- 51. PAVING REPAIR: SAWCUT EXISTING PAVEMENT FOR NEW INSTALLATION WHERE REQUIRED. UP ON COMPLETION OF THE INSTALLATION OF THE SEPTIC SYSTEM, BACKFILL AND RE-PAVE TO MATCH EXISTING SURROUNDINGS

STORM WATER POLLUTION CONTROL REQUIREMENTS FOR CONSTRUCTION ACTIVITIES. MINIMUM WATER QUALITY PROTECTION REQUIREMENTS FOR ALL CONSTRUCTION PROJECTS/CERTIFICATION STATEMENT

THE FOLLOWING SHALL BE EITHER INCORPORATED OR ATTACHED TO THE APPROVED CONSTRUCTION/GRADING PLANS AND REPRESENT THE MINIMUN STANDARDS OF GOOD HOUSEKEEPING WHICH MUST BE IMPLEMENTED IN ALL CONSTRUCTION PROJECTS. CONSTRUCTION INCLUDES ACTIVITIES SUCH AS CONSTRUCTING, CLEARING, GRADING OR EXCAVATION THAT RESULTS IN SOIL NOT INCLUDE ROUTINE MAINTENANCE TO MAINTAIN THE ORIGINAL LINE AND GRADE, HYDRAULIC CAPACITY, OR ORIGINAL PURPOSE OF FACILITIES EXPOSURE OF CONSTRUCTION MATERIAL OR CONSTRUCTION WASTE TO STORM WATER; MECHANICAL PERMIT WORK; OR SIGN PERMIT WORK.

-ERODED SEDIMENTS AND OTHER POLLUTANTS MUST BE RETAINED ON SITE AND MAY NOT BE TRANSPORTED FROM THE SITE VIA SHEET FLOW, SWALES, AREA DRAINS. NATURAL DRAINAGE COURSE OR WIND

-STOCKPILES OF EARTH AND OTHER CONSTRUCTION RELATED MATERIAL MUST BE PROTECTED FROM BEING TRANSPORTED FROM THE SITE BY WIND OR WATER.

-FUELS, OIL'S, SOLVENTS AND OTHER TOXIC MATERIALS MUST BE STORED IN ACCORDANCE WITH THEIR LIST AND NOT TO CONTAMINATE THE SOIL OR THE SURFACE WATER. ALL APPROVED TOXIC STORAGE CONTAINERS ARE TO BE PROTECTED FROM THE WEATHER. SPILLS MUST BE CLEANED UP IMMEDIATELY AND DISPOSED OF IN A PROPER MANNER. SPILLS MAY NOT BE WASHED INTO THE DRAINAGE SYSTEM.

-NON-STORM WATER RUNOFF FROM EQUIPMENTS AND VEHICLE WASHING AND ANY OTHER ACTIVITY SHALL BE CONTAINED AT THE PROJECT SITE.

-EXCESS OR WASTE CONCRETE MAY NOT BE WASHED INTO THE PUBLIC WAY OR ANY DRAINAGE SYSTEM. PROVISIONS SHALL BE MADE TO RETAIN CONCRETE WASTE ON-SITE UNTIL THEY CAN BE APPROPRIATELY DISPOSED OF OR RECYCLED.

-TRASH AND CONSTRUCTION-RELATED WASTE MUST BE DEPOSITED INTO A COVERED RECEPTACLE TO PREVENT CONTAMINATION OF RAINWATER AND DISPERSAL BY WIND.

-SEDIMENTS AND OTHER MATERIALS MAY NOT BE TRACKED FROM THE SITE. THE CONSTRUCTION ENTRANCE ROADWAYS MUST BE STABILIZED SO AS TO INHIBIT SEDIMENTS FROM BEING DEPOSITED INTO THE PUBLIC WAYS. ACCIDENTAL DEPOSITIONS MUST BE SWEPT UP IMMEDIATELY AND MAY NOT BE WASHED DOWN BY RAIN OR BY ANY OTHER MEANS

AS A PROJECT OWNER OR AUTHORIZED AGENT OF THE OWNER I HAVE READ AND UNDERSTAND THE REQUIREMENTS, LISTED ABOVE, NECESSARY TO CONTROL STORM WATER POLLUTION FROM SEDIMENTS, EROSION, AND CONSTRUCTION MATERIALS, AND I CERTIFY THAT I WILL COMPLY WITH THESE REQUIREMENTS.

______ (OWNER OR AUTHORIZED AGENT OF THE OWNER)

______ (OWNER OR AUTHORIZED AGENT OF THE OWNER)

PRELIMINARY NOT FOR CONSTRUCTION

VICINITY MAP



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6080 CENTER DRIVE SUITE 700 LOS ANGELES, CA 90045 TEL: 310.665.2800 FAX: 310.665.9075

WATER RECYCLING SYSTEMS

1715 VIA EL PRADO #414 REDONDO BEACH, CA 90277 CALIFORNIA DISTRIBUTOR: BUZZ BOETCHNER TEL: (310) 463-2634 EMAIL: BUZZ@REUSEGRAYWATER.COM WWW.REUSEGRAYWATER.COM

WAGNER ENGINEERING & SURVEY, INC.

14930 VENTURA BLVD SUITE 240 SHERMAN OAKS, CA 91403 TEL: 818.995.9880 FAX: 818.995.9877

DRAWING INDEX

SHEET DESCRIPTION

W-1 RAIN WATER HARVESTING TITLE SHEET AND NOTES

W-2 RAIN WATER HARVESTING SYSTEM SITE PLAN

W-3 ENLARGED RAIN WATER HARVESTING SYSTEM SITE PLAN W-4 ENLARGED RAIN WATER HARVESTING ELECTRICAL PLAN

W-5 PROCESS FLOW SCHEMATIC/ISOMETRIC

W-6 RAIN WATER HARVESTING SYSTEM DETAILS

W-7 RAIN WATER HARVESTING SYSTEM DETAILS

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PROJECT

KoningEizenbergArchitectur

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All designs, ideas, arrangements and plan disclosed to any other person for any us

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06/12/2012

RAIN WATER HARVESTING TITLE SHEET AND NOTES

W-1

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ARCHITECT'S PROJECT NO.

ARCHITECT

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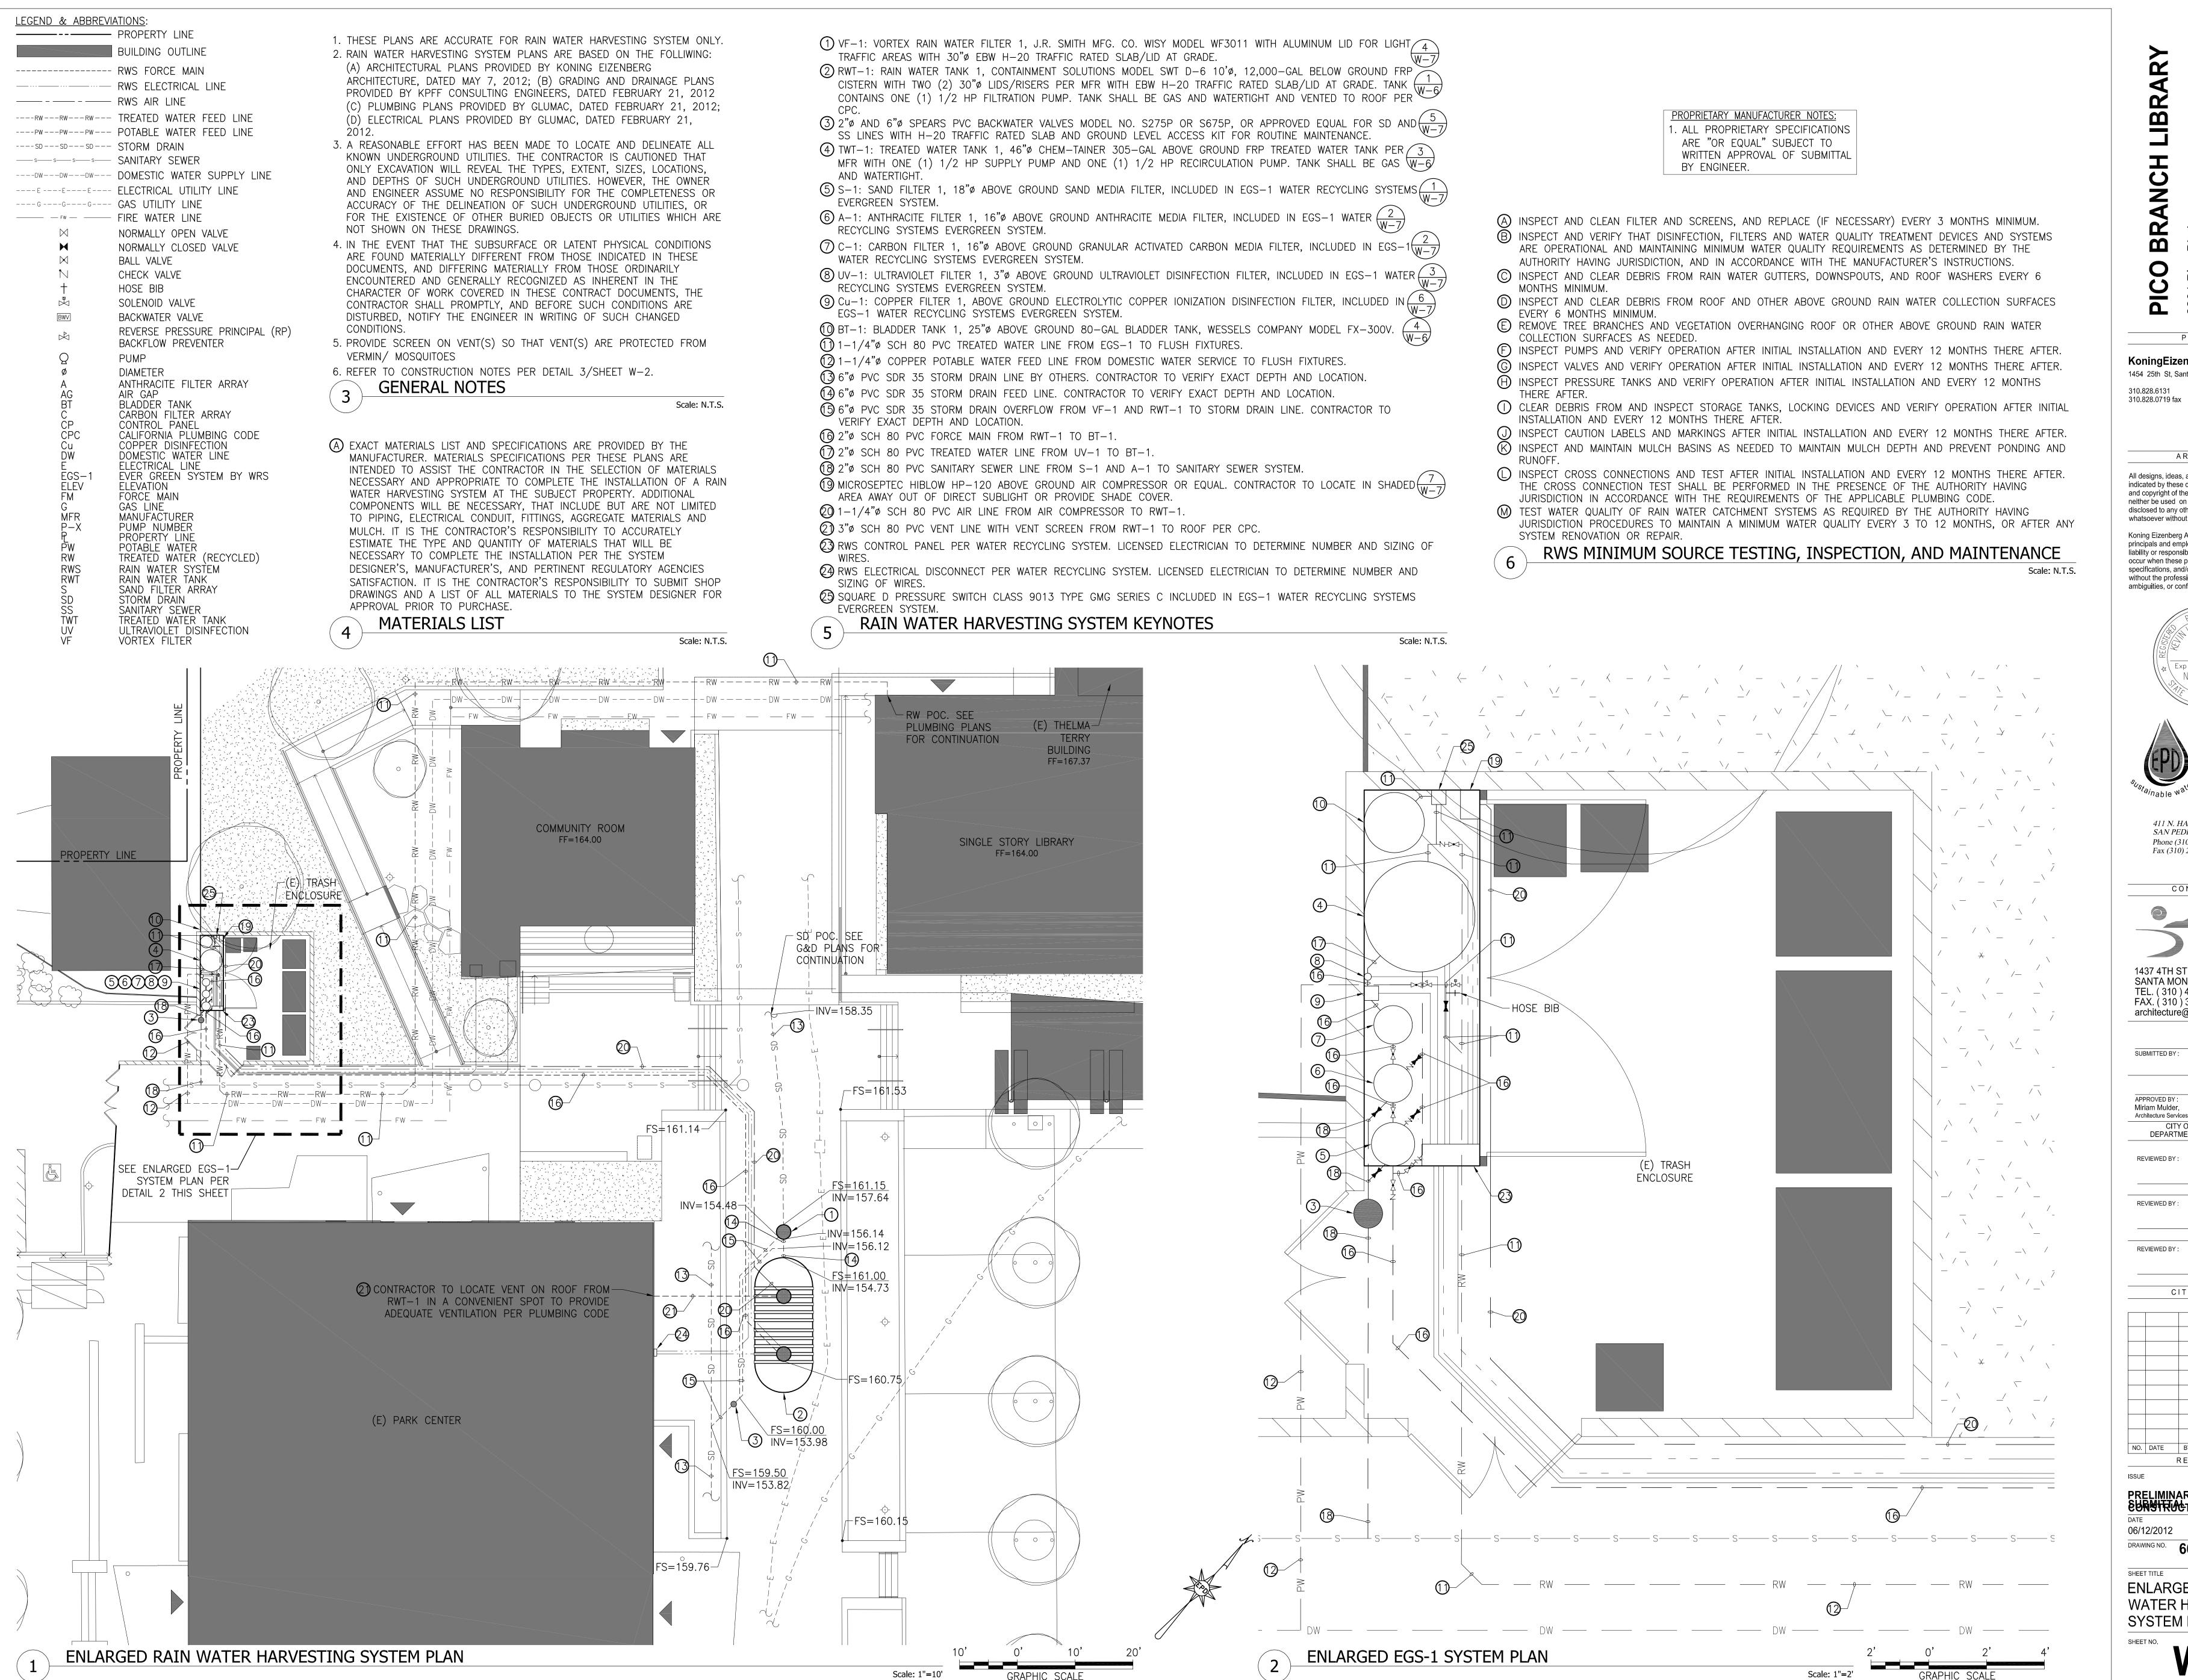
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> > ARCHITECT

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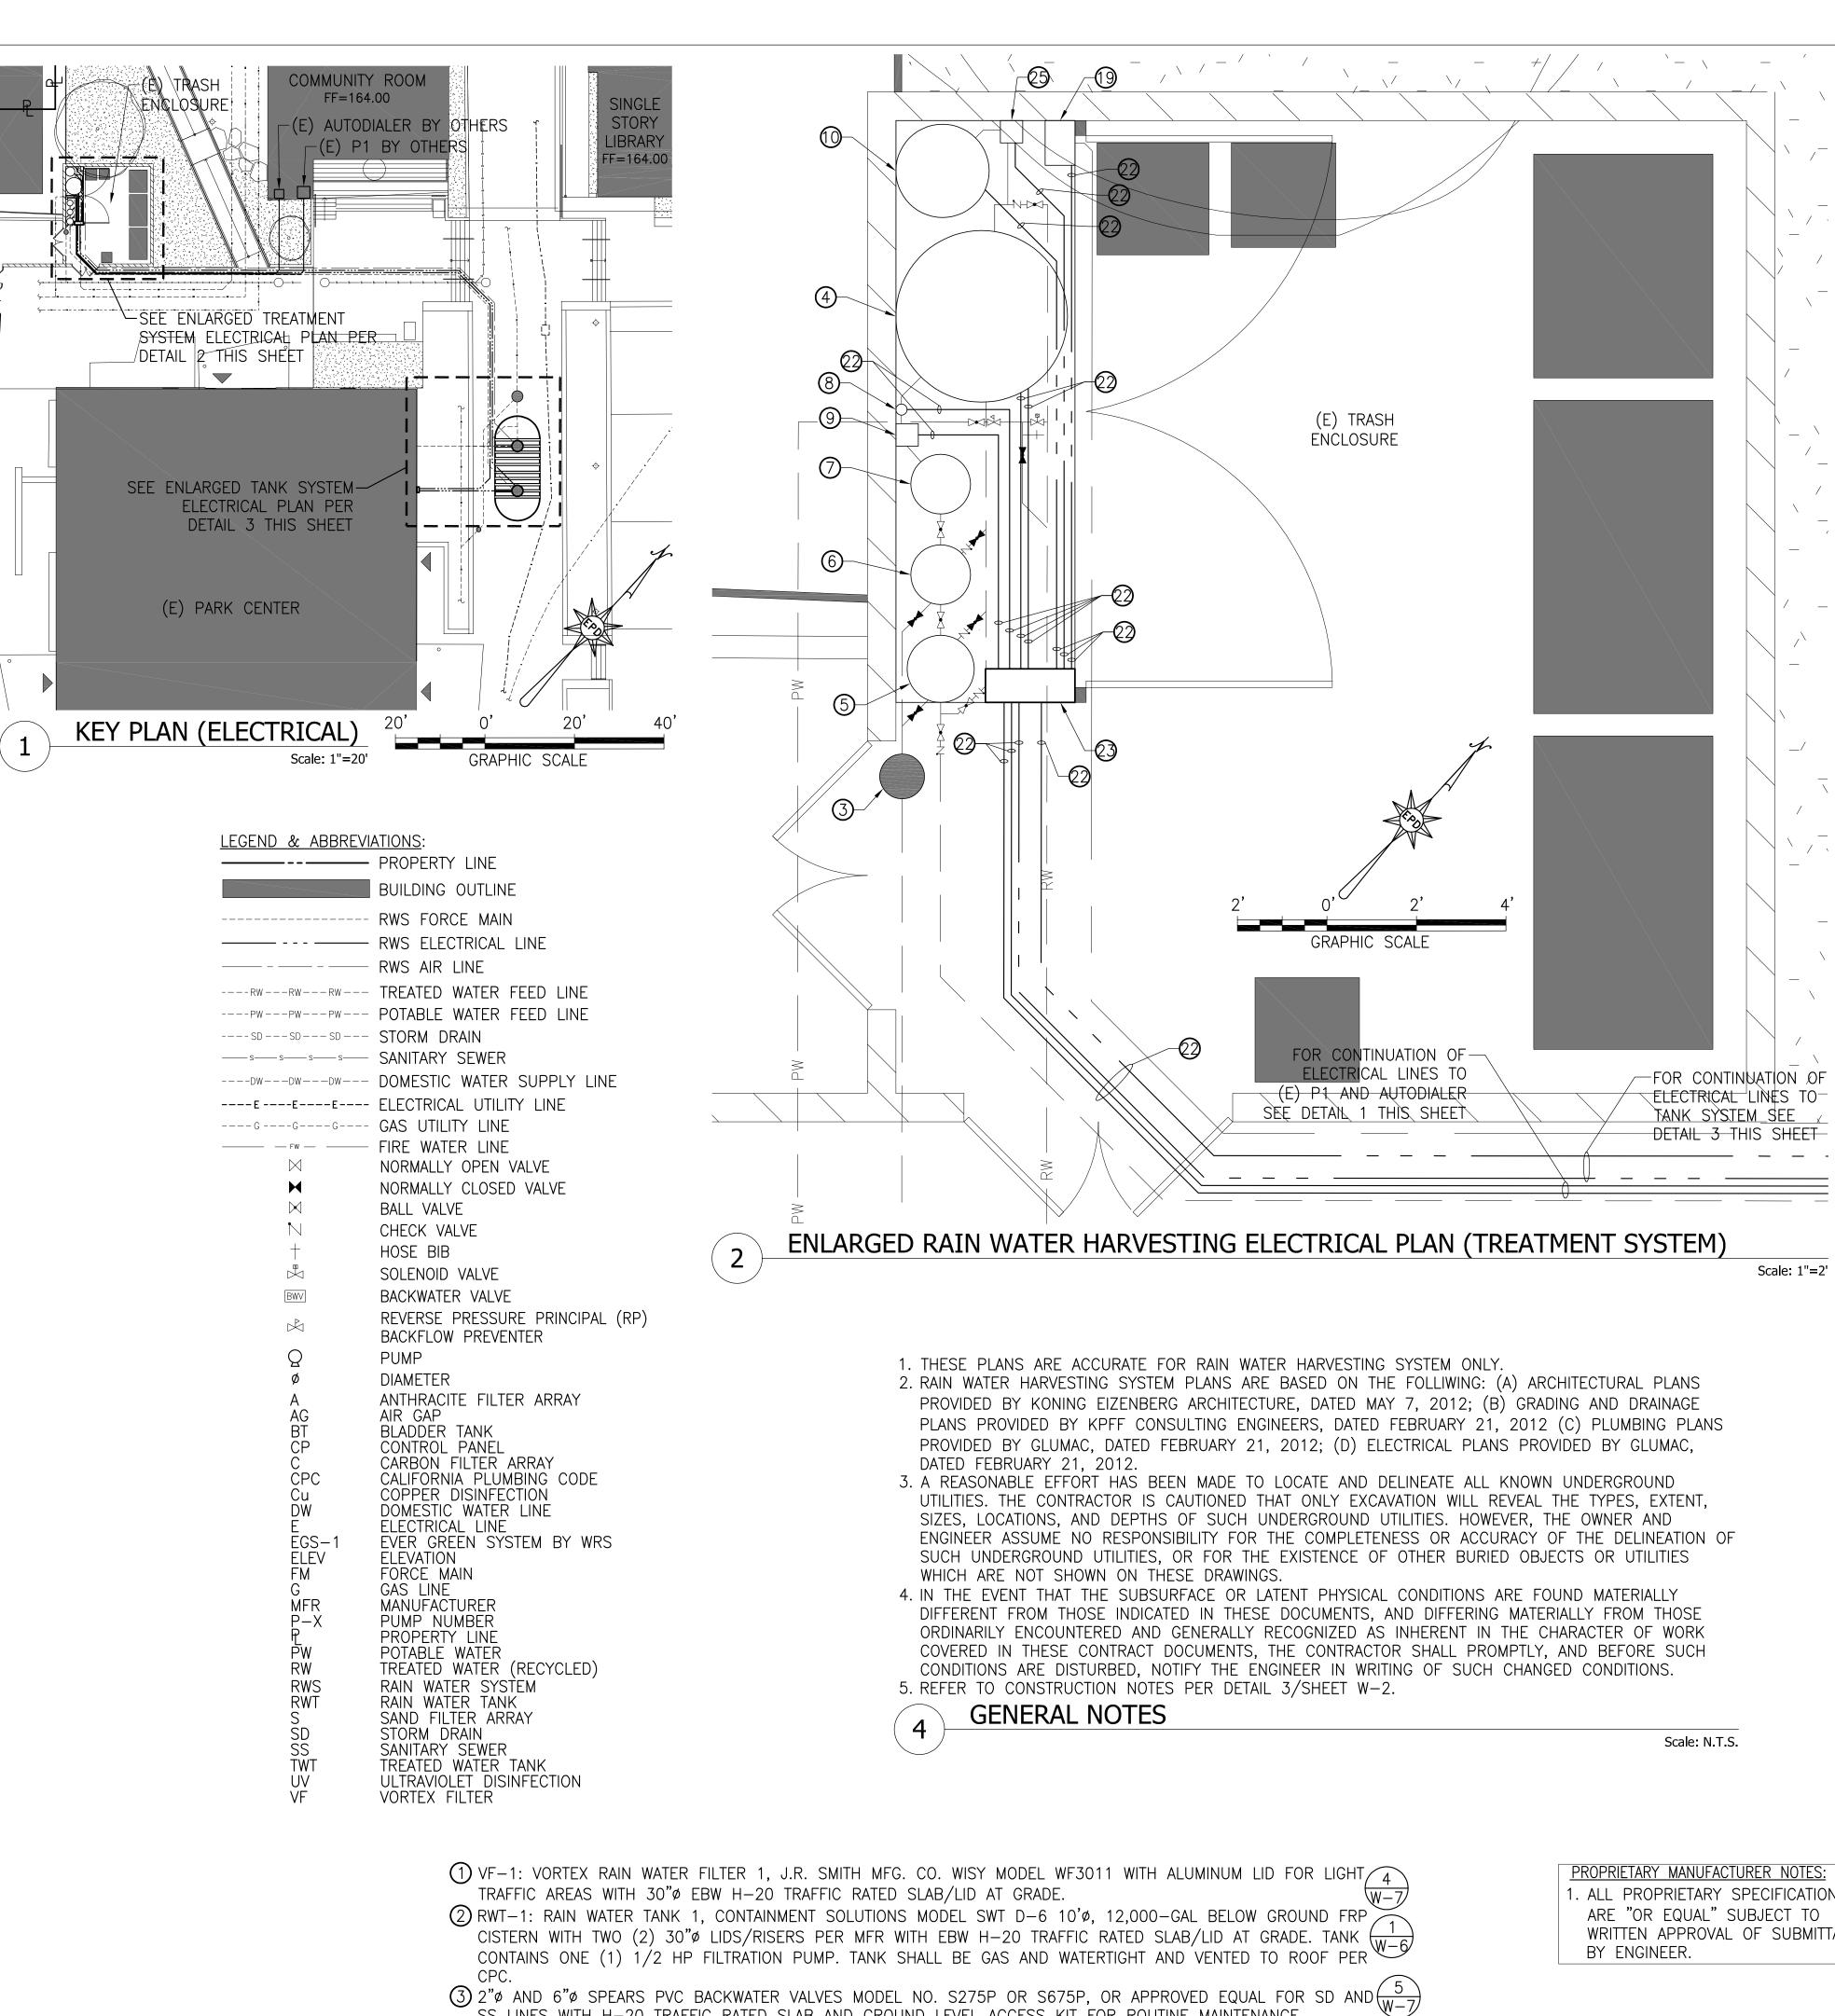
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06/12/2012 DRAWING NO. 6693

ENLARGED RAIN WATER HARVESTING SYSTEM PLAN



SS LINES WITH H-20 TRAFFIC RATED SLAB AND GROUND LEVEL ACCESS KIT FOR ROUTINE MAINTENANCE. 4) TWT-1: TREATED WATER TANK 1, 46"ø CHEM-TAINER 305-GAL ABOVE GROUND FRP TREATED WATER TANK PER 3 MFR WITH ONE (1) 1/2 HP SUPPLY PUMP AND ONE (1) 1/2 HP RECIRCULATION PUMP. TANK SHALL BE GAS $\sqrt{W-6}$

 \bigcirc S-1: SAND FILTER 1, 18" ABOVE GROUND SAND MEDIA FILTER, INCLUDED IN EGS-1 WATER RECYCLING SYSTEMS \bigcirc 1.

6 A-1: ANTHRACITE FILTER 1, 16" ABOVE GROUND ANTHRACITE MEDIA FILTER, INCLUDED IN EGS-1 WATER $\frac{2}{W-7}$ RECYCLING SYSTEMS EVERGREEN SYSTEM.

 \bigcirc C-1: CARBON FILTER 1, 16"\(\phi\) ABOVE GROUND GRANULAR ACTIVATED CARBON MEDIA FILTER, INCLUDED IN EGS-1 $\left(\frac{2}{W-7} \right)$ WATER RECYCLING SYSTEMS EVERGREEN SYSTEM.

8 UV−1: ULTRAVIOLET FILTER 1, 3"ø ABOVE GROUND ULTRAVIOLET DISINFECTION FILTER, INCLUDED IN EGS−1 WATER RECYCLING SYSTEMS EVERGREEN SYSTEM.

(9) Cu-1: COPPER FILTER 1, ABOVE GROUND ELECTROLYTIC COPPER IONIZATION DISINFECTION FILTER, INCLUDED IN EGS-1 WATER RECYCLING SYSTEMS EVERGREEN SYSTEM.

(10) BT-1: BLADDER TANK 1, 25" ABOVE GROUND 80-GAL BLADDER TANK, WESSELS COMPANY MODEL FX-300V.

(9) MICROSEPTEC HIBLOW HP-120 ABOVE GROUND AIR COMPRESSOR OR EQUAL. CONTRACTOR TO LOCATE IN SHADED $(\frac{7}{110})$ AREA AWAY OUT OF DIRECT SUBLIGHT OR PROVIDE SHADE COVER. (2) 1" SCH 80 PVC RWS ELECTRICAL LINES. CONTRACTOR SHALL HAVE LICENSED ELECTRICIAN DETERMINE THE

NUMBER AND SIZING OF WIRES. 23 RWS CONTROL PANEL PER WATER RECYCLING SYSTEM. LICENSED ELECTRICIAN TO DETERMINE NUMBER AND SIZING OF


RAIN WATER HARVESTING SYSTEM KEYNOTES


(24) RWS ELECTRICAL DISCONNECT PER WATER RECYCLING SYSTEM. LICENSED ELECTRICIAN TO DETERMINE NUMBER AND

SIZING OF WIRES. 25 SQUARE D PRESSURE SWITCH CLASS 9013 TYPE GMG SERIES G INCLUDED IN EGS-1 WATER RECYCLING SYSTEMS

Scale: N.T.S.

PROPRIETARY MANUFACTURER NOTES: 1. ALL PROPRIETARY SPECIFICATIONS ARE "OR EQUAL" SUBJECT TO WRITTEN APPROVAL OF SUBMITTAL

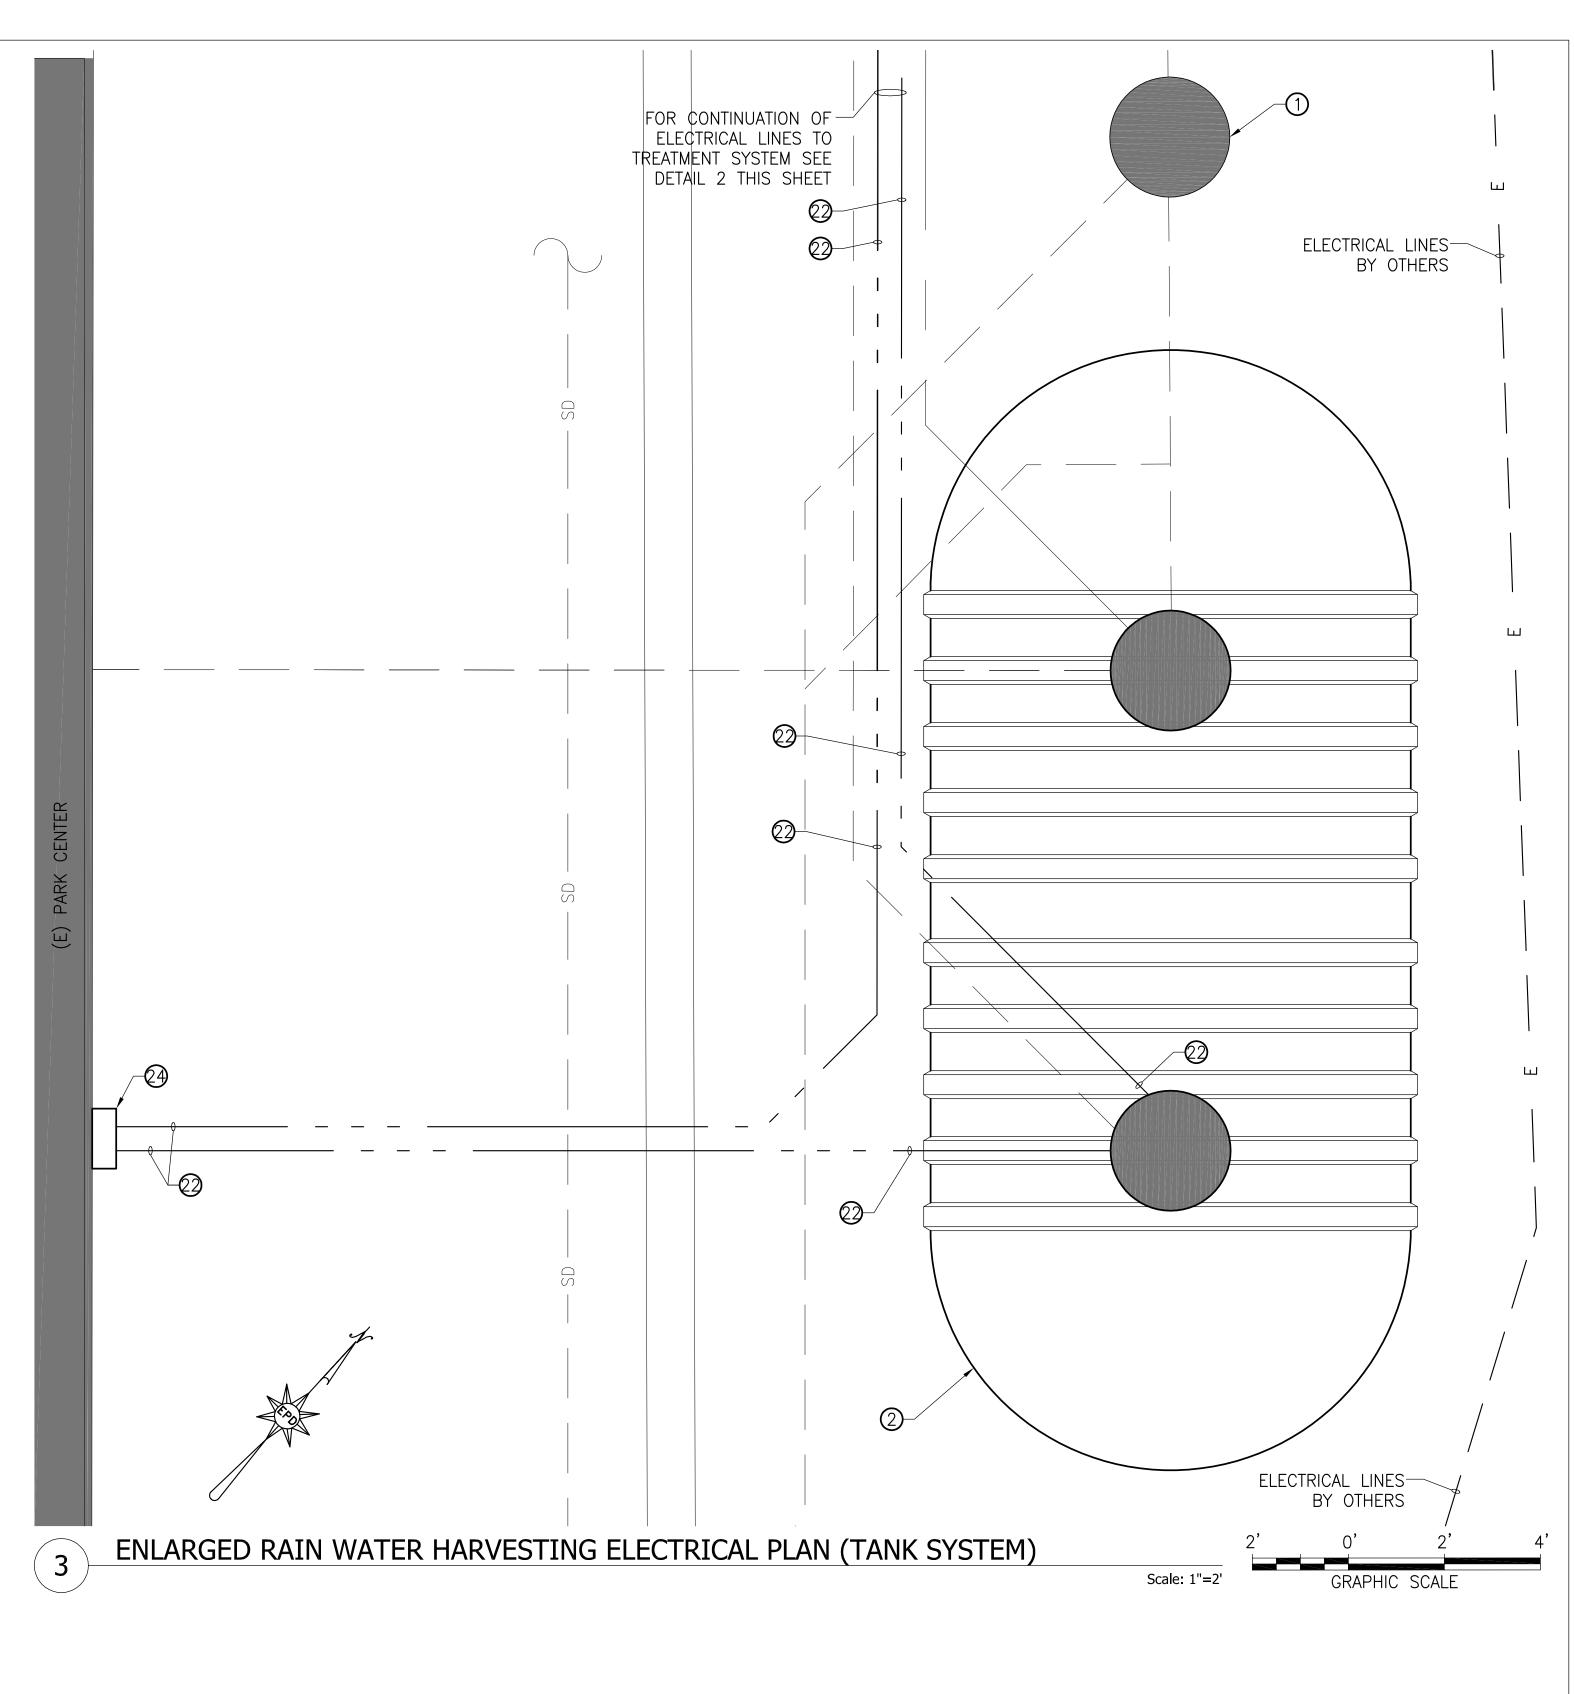

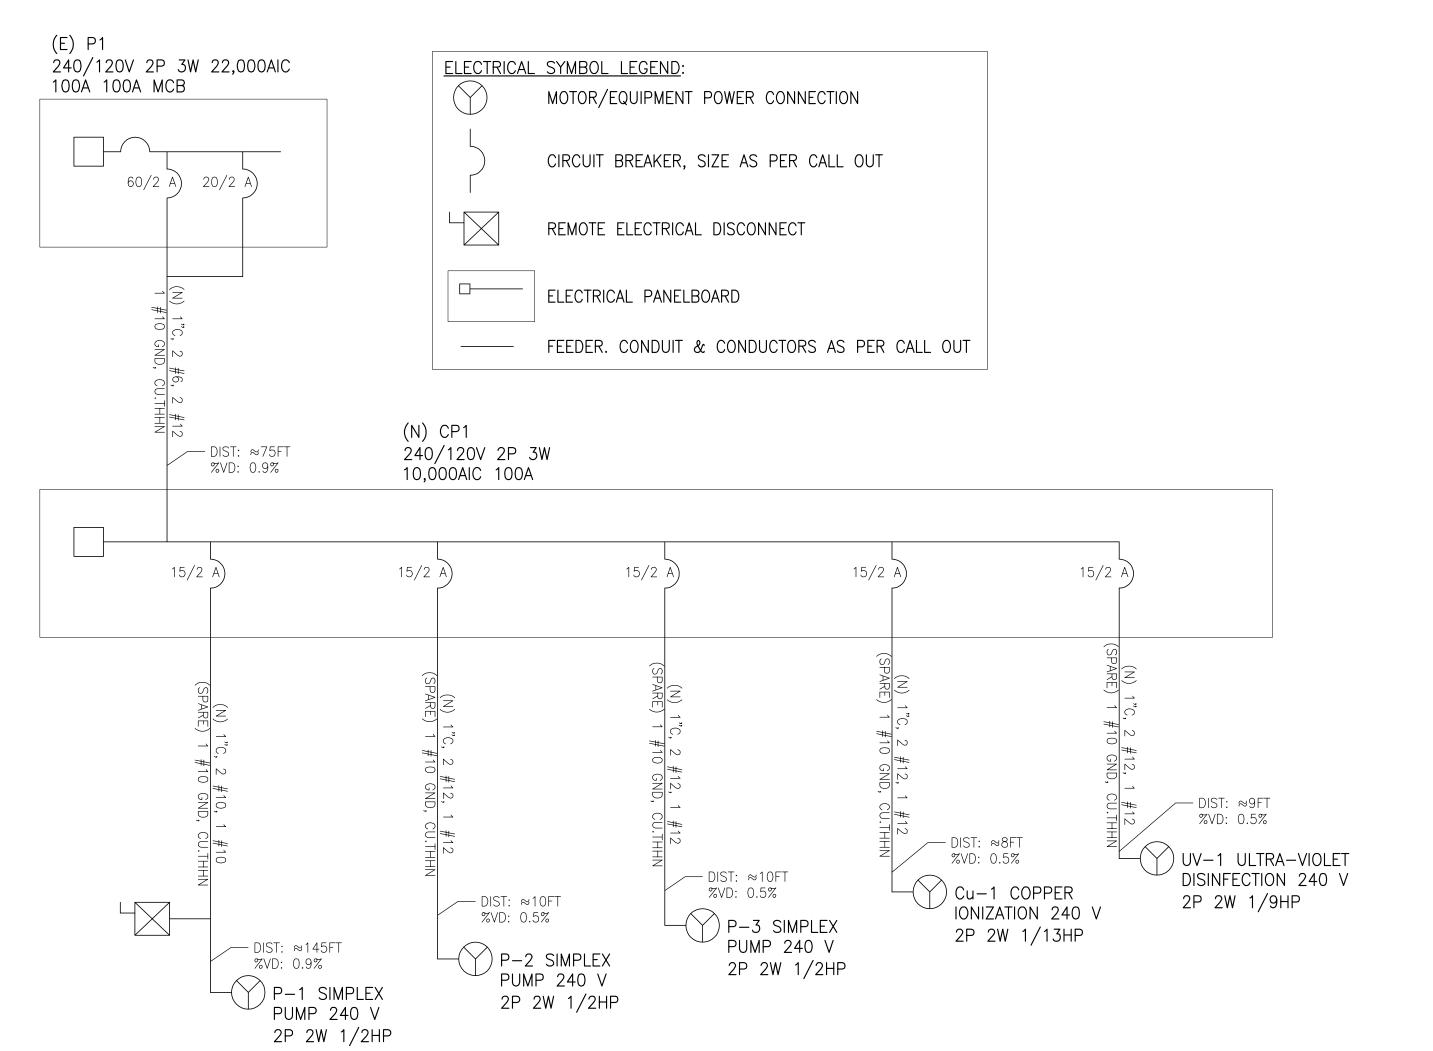

RAIN WATER HARVESTING SYSTEM ELECTRICAL LINE DIAGRAM

LIBRA C BR A PROJECT

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ARCHITECT'S PROJECT NO.

ARCHITECT

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NO. DATE BY DESCRIPTION REVISIONS

PRELIMINARY-NOT FOR CONSTRUCTION 06/12/2012

DRAWING NO. 6693 SHEET TITLE **ENLARGED RAIN** WATER HARVESTING

ELECTRICAL PLAN

Scale: N.T.S.

LEGEND & ABBREVIATIONS:

— — — — — RWS FORCE MAIN

----- RWS AIR LINE

------ S------ RWS SANITARY SEWER

----- RWS ELECTRICAL LINE

->> TREATED WATER FEED LINE

--- POTABLE WATER FEED LINE

— STORM DRAIN

----- W ----- DOMESTIC WATER SUPPLY LINE

BALL VALVE

HOSE BIB

DIAMETER

AIR GAP

BLADDER TANK

CONTROL PANEL

LECTRICAL LINE

ELEVATION

FORCE MAIN

MANUFACTURER

PUMP NUMBER PROPERTY LINE POTABLE WATER

RAIN WATER SYSTEM

SAND FILTER ARRAY

RAIN WATER TANK

STORM DRAIN

GAS LINE

RWS

CHECK VALVE

SOLENOID VALVE

BACKWATER VALVE

BACKFLOW PREVENTER

ANTHRACITE FILTER ARRAY

CALIFORNIA PLUMBING CODE

EVER GREEN SYSTEM BY WRS

TREATED WATER (RECYCLED)

CARBON FILTER ARRAY

COPPER DISINFECTION

DOMESTIC WATER LINE

NORMALLY OPEN VALVE

NORMALLY CLOSED VALVE

REVERSE PRESSURE PRINCIPAL (RP)

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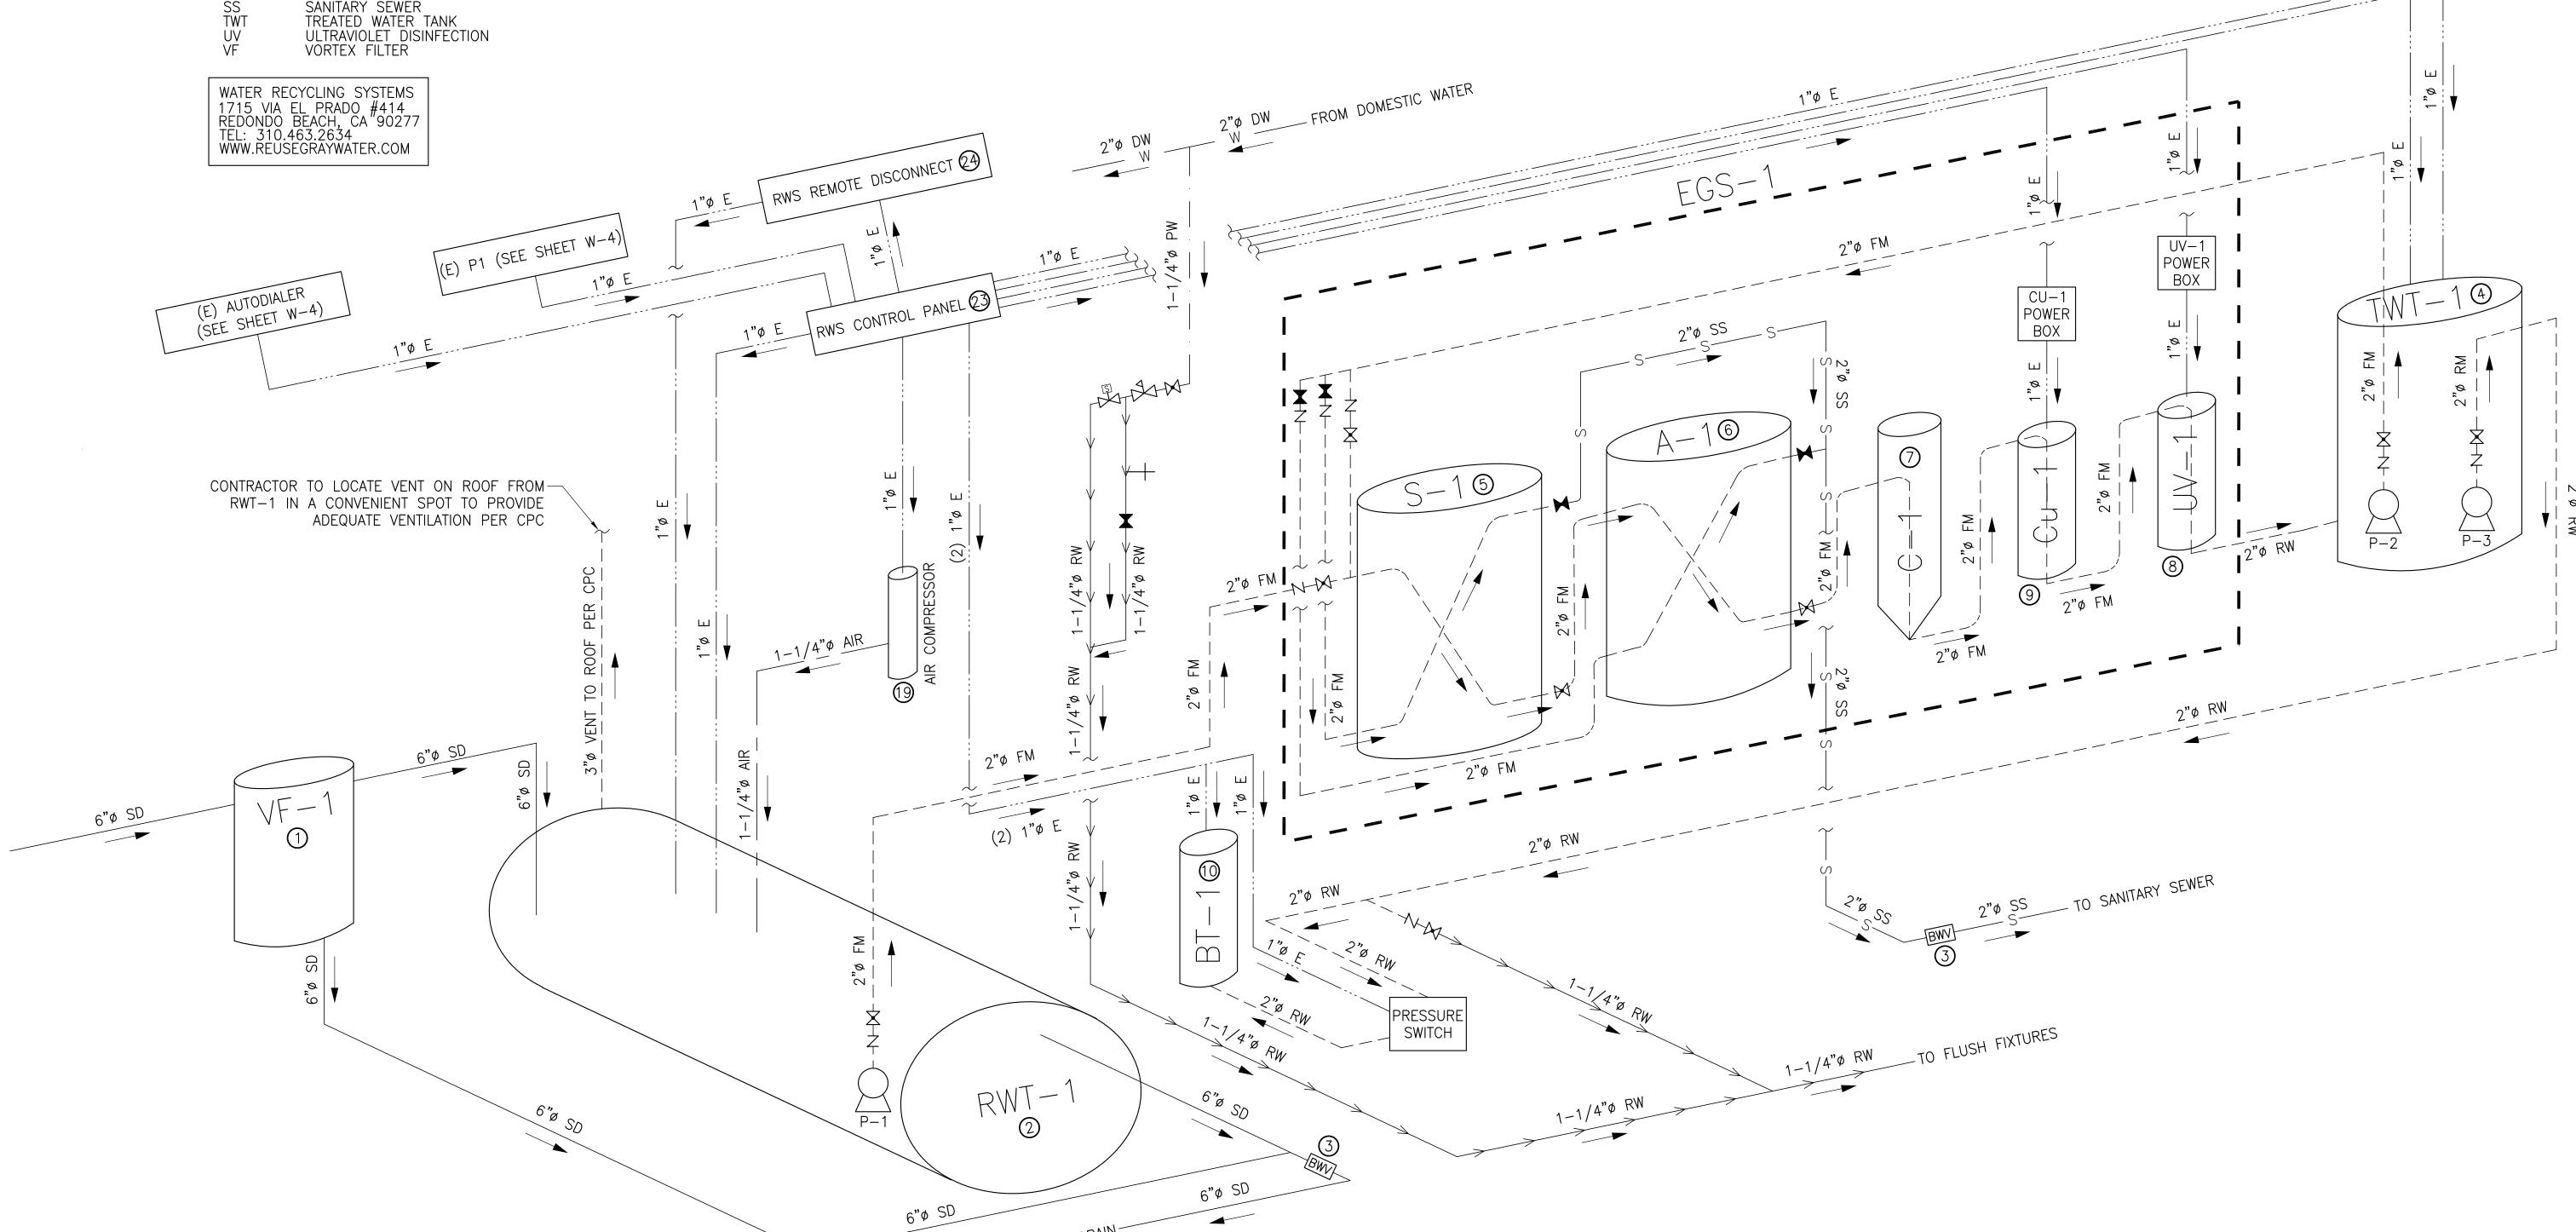
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DRAWING NO. **6693** PROCESS FLOW

SCHEMATIC/ISOMETRIC

(1) VF-1: VORTEX RAIN WATER FILTER 1, J.R. SMITH MFG. CO. WISY MODEL WF3011 WITH ALUMINUM LID FOR LIGHT $\sqrt{4}$ EQUIPMENT TABLE TRAFFIC AREAS WITH 30" Ø EBW H-20 TRAFFIC RATED SLAB/LID AT GRADE. 2 RWT-1: RAIN WATER TANK 1, CONTAINMENT SOLUTIONS MODEL SWT D-6 10'0, 12,000-GAL BELOW GROUND FRP TYPE SIZE | MANUFACTURER |PRODUCT # CISTERN WITH TWO (2) 30"0 LIDS/RISERS PER MFR WITH EBW H-20 TRAFFIC RATED SLAB/LID AT GRADE. TANK | 1–1/4" | SPEARS PVC TRUE UNION BALL VALVE BALL VALVE USA BLUEBOOK STOCK #76903 CONTAINS ONE (1) 1/2 HP FILTRATION PUMP. TANK SHALL BE GAS AND WATERTIGHT AND VENTED TO ROOF PER USA BLUEBOOK STOCK #76905 BALL VALVE SPEARS PVC TRUE UNION BALL VALVE CPC. (3) 2" AND 6" SPEARS PVC BACKWATER VALVES MODEL NO. S275P OR S675P, OR APPROVED EQUAL FOR SD AND $\frac{3}{W}$ | 1-1/4" | SPEARS PVC TRUE UNION CHECK VALVE |SPEARS #2223-012 CHECK VALVE SPEARS PVC TRUE UNION CHECK VALVE SPEARS #2223-020 SS LINES WITH H-20 TRAFFIC RATED SLAB AND GROUND LEVEL ACCESS KIT FOR ROUTINE MAINTENANCE. CHECK VALVE (4) TWT-1: TREATED WATER TANK 1, 46" CHEM-TAINER 305-GAL ABOVE GROUND FRP TREATED WATER TANK PER 3 USA BLUEBOOK STOCK #72699 SOLENOID VALVE 1-1/4" | BURKERT BRASS SOLENOID VALVE MFR WITH ONE (1) 1/2 HP SUPPLY PUMP AND ONE (1) 1/2 HP RECIRCULATION PUMP. TANK SHALL BE GAS $\overline{\mathbb{W}}-\overline{6}/\overline{\mathbb{W}}$ USA BLUEBOOK STOCK #28282 BACKWATER VALVE SPEARS PVC BACKWATER VALVE WITH EXTENSIONS AND WATERTIGHT. BACKWATER VALVE SPEARS PVC BACKWATER VALVE WITH EXTENSIONS USA BLUEBOOK STOCK #28285 5 S-1: SAND FILTER 1, 18" ABOVE GROUND SAND MEDIA FILTER, INCLUDED IN EGS-1 WATER RECYCLING SYSTEMS $\frac{1}{W-7}$ 3/4" | J.R. SMITH NON-FREEZE ABOVE GROUND HYDRANT J.R. SMITH MODEL #5616 HOSE BIB EVERGREEN SYSTEM. 6 A-1: ANTHRACITE FILTER 1, 16" Ø ABOVE GROUND ANTHRACITE MEDIA FILTER, INCLUDED IN EGS-1 WATER $\frac{2}{W-7}$ BACKFLOW PREVENTER |1-1/4"| WILKINS 975XL RPZ BRASS BACKFLOW PREVENTER USA BLUEBOOK STOCK #15873 ALL RAIN WATER HARVESTING EQUIPMENT COMPONENTS LISTED IN THE EQUIPMENT TABLE ARE "OR EQUAL" SUBJECT TO WRITTEN APPROVAL OF RECYCLING SYSTEMS EVERGREEN SYSTEM. SUBMITTAL BY ENGINEER. (7) C-1: CARBON FILTER 1, 16" ABOVE GROUND GRANULAR ACTIVATED CARBON MEDIA FILTER, INCLUDED IN EGS-1 $(\frac{2}{110})$ WATER RECYCLING SYSTEMS EVERGREEN SYSTEM. \otimes UV $_{-1}$: ULTRAVIOLET FILTER 1, 3"ø ABOVE GROUND ULTRAVIOLET DISINFECTION FILTER, INCLUDED IN EGS $_{-1}$ WATER $\left(\frac{1}{14} \right)$ RECYCLING SYSTEMS EVERGREEN SYSTEM. \bigcirc Cu-1: COPPER FILTER 1, ABOVE GROUND ELECTROLYTIC COPPER IONIZATION DISINFECTION FILTER, INCLUDED IN \bigcirc PROPRIETARY MANUFACTURER NOTES: EGS-1 WATER RECYCLING SYSTEMS EVERGREEN SYSTEM. 1. ALL PROPRIETARY SPECIFICATIONS \bigcirc BT-1: BLADDER TANK 1, 25" ABOVE GROUND 80-GAL BLADDER TANK, WESSELS COMPANY MODEL FX-300V. \bigcirc ARE "OR EQUAL" SUBJECT TO 19 MICROSEPTEC HIBLOW HP-120 ABOVE GROUND AIR COMPRESSOR OR EQUAL. CONTRACTOR TO LOCATE IN SHADED $\frac{7}{W-}$ WRITTEN APPROVAL OF SUBMITTAL AREA AWAY OUT OF DIRECT SUBLIGHT OR PROVIDE SHADE COVER. BY ENGINEER. 23 RWS CONTROL PANEL PER WATER RECYCLING SYSTEM. LICENSED ELECTRICIAN TO DETERMINE NUMBER AND SIZING OF WIRES. RWS ELECTRICAL DISCONNECT PER WATER RECYCLING SYSTEM. LICENSED ELECTRICIAN TO DETERMINE NUMBER AND SIZING OF WIRES. 25 SQUARE D PRESSURE SWITCH CLASS 9013 TYPE GMG SERIES C INCLUDED IN EGS-1 WATER RECYCLING SYSTEMS RAIN WATER HARVESTING SYSTEM KEYNOTES




PROCESS FLOW SCHEMATIC / ISOMETRIC

Scale: N.T.S.

Scale: N.T.S.

RWT-1: RAIN WATER TANK 1 DETAIL

PROPRIETARY MANUFACTURER NOTES: 1. ALL PROPRIETARY SPECIFICATIONS ARE "OR EQUAL" SUBJECT TO WRITTEN APPROVAL OF SUBMITTAL BY ENGINEER.

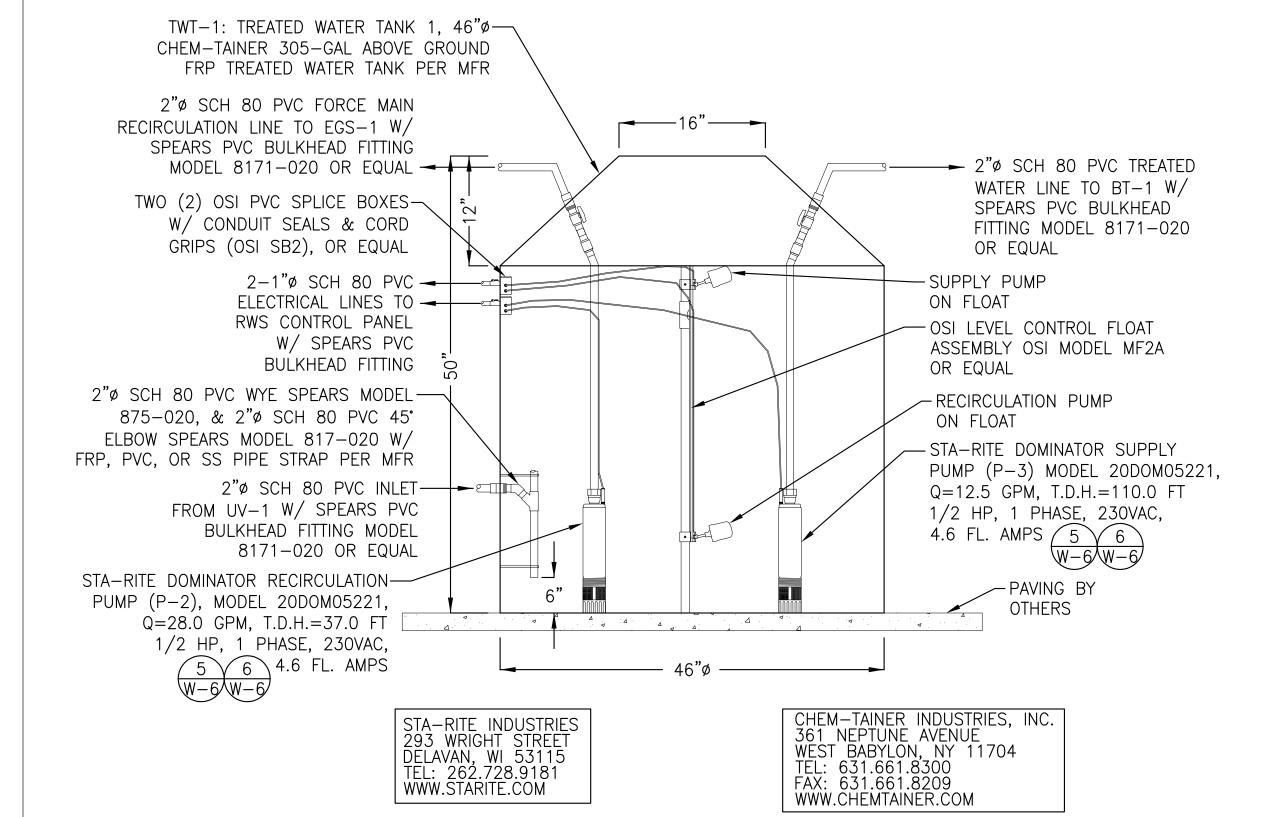


GENERAL NOTES:

- 1. CONTRACTOR SHALL FOLLOW TANK MANUFACTURER'S INSTALLATION INSTRUCTIONS. FOR COMPLETE DESIGN AND PRODUCT
- INFORMATION CONTACT CHEM-TAINER INDUSTRIES, INC. OR WATER RECYCLING SYSTEMS. 2. THE ABOVE GROUND TANK SHALL BE ANCHORED TO THE GROUND OR PAVING PER TANK MANUFACTURER'S
- RECOMMENDATIONS. 3. REFER TO TANK NOTES PER DETAIL 2 THIS SHEET.
- 4. TANK SHALL BE PERMANENTLY MARKED WITH THE FOLLOWING, "RAIN WATER HARVESTING SYSTEM, CAUTION-UNSAFE WATER."
- 5. ALL PUMPS, FLOATS AND CONTROL PANEL WIRING SUBMITTALS SHALL BE PROVIDED BY THE CONTRACTOR TO THE SYSTEM DESIGNER PRIOR TO COMMENCEMENT OF ELECTRICAL WORK.

TWT-1: TREATED WATER TANK 1 DETAIL

BT-1: BLADDER TANK 1 DETAIL

Scale: N.T.S.

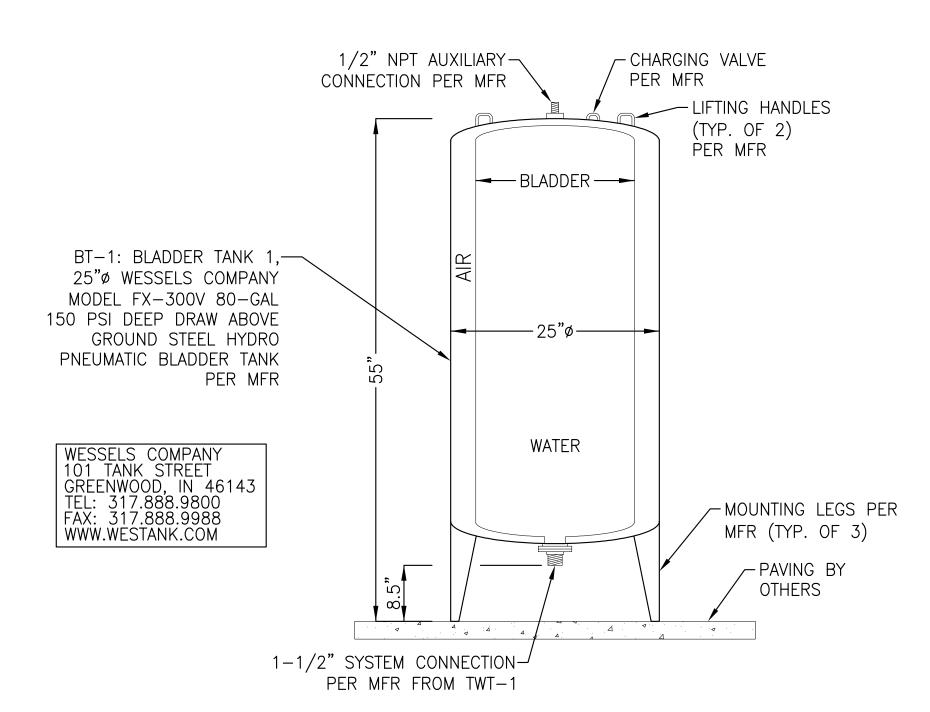

GENERAL NOTES:

Scale: N.T.S.

- 1. CONTRACTOR SHALL FOLLOW TANK MANUFACTURER'S INSTALLATION INSTRUCTIONS. FOR COMPLETE DESIGN AND PRODUCT INFORMATION CONTACT WESSELS COMPANY OR WATER RECYCLING SYSTEMS.
- 2. THE ABOVE GROUND TANK SHALL BE ANCHORED TO THE GROUND OR PAVING PER TANK MANUFACTURER'S RECOMMENDATIONS.
- 3. REFER TO TANK NOTES PER DETAIL 2 THIS SHEET.

A TANKS AND EQUIPMENT SHALL BE INSTALLED IN ACCORDANCE WITH MANUFACTURER'S RECOMMENDATIONS AND CERTIFIED BY MANUFACTURER AND/OR CONTRACTOR

(B) CONTRACTOR SHALL SUBMIT SHOP DRAWINGS FROM TANK MANUFACTURER DETAILING TANK PENETRATIONS, BRACKETS, & OTHER APPURTENANCES PRIOR TO TANK

🖒 IF THE SOIL HAS LESS THAN 750 LBS./SQ.FT. COHESION AS CALCULATED FROM AN UNCONFINED COMPRESSION TEST; OR IN SOILS HAVING AN ULTIMATE BEARING CAPACITY OF LESS THAN 3,500 LBS./SQ. FT.; OR WHERE SOIL WILL NOT MAINTAIN A VERTICAL WALL, THE EXCAVATION MUST ALLOW A MINIMUM SPACE EQUAL TO HALF THE DIAMETER OF THE TANK BETWEEN THE SIDE AND THE ENDCAP OF THE TANK. AND THE EXCAVATION WALL TO ENHANCE LATERAL

RESISTANCE. (D) A REINFORCED CONCRETE SLAB MAY BE REQUIRED UNDER THE TANK AS A FOUNDATION IN THE EXCAVATION WHERE THE BOTTOM IS UNSTABLE. ASPHALT AND

CONCRETE SLABS MUST EXTEND A MINIMUM OF 12" BEYOND THE TANK IN ALL DIRECTIONS. (E) TANKS SHALL BE ANCHORED PER MANUFACTURER'S RECOMMENDATIONS IN INSTALLATIONS IN WHICH THE TANK COULD BE EXPOSED TO WATER. SITES SHALL BE THOROUGHLY EVALUATED FOR THE POTENTIAL OF A RISE IN THE LOCAL WATER TABLE OR OF TRAPPED WATER. CONTRACTOR OR SOILS ENGINEER SHALL PROVIDE EVALUATION TO SYSTEM DESIGNER FOR REVIEW PRIOR TO INSTALLATION OF TANK.

(H) THE MAXIMUM DESIGNED TANK BURY DEPTH IS 7' OF COVER OVER THE TOP OF THE TANK PER MANUFACTURER. ANY TANK BURIED BEYOND RANGE NEEDS TO BE ANALYZED BY A CIVIL/ GEOTECHNICAL ENGINEER PER MANUFACTURER

(I) ACCESS RISERS TO BE SET/GLUED IN FIELD BY CONTRACTOR AND WATER TESTED AFTER INSTALLATION IN ACCORDANCE WITH CONSTRUCTION SPECIFICATIONS AND IN THE PRESENCE OF ENGINEER, OWNER, OR OWNER'S AGENT. LIDS SHALL BE LOCKING AND MARKED "RAIN WATER HARVESTING SYSTEM, CAUTON-UNSAFE

(J) IF THERE IS AN UNATTACHED RISER OVER AN ACCESS OPENING, IT MUST NOT TRANSMIT LOAD FROM THE ASPHALT OR CONCRETE SLAB TO THE TANK. A

MINIMUM SPACE OF 6" MUST EXIST BETWEEN THE BOTTOM OF THE RISER AND THE TOP OF THE TANK. (K) IF THERE IS AN ATTACHED RISER ON AN ACCESS OPENING, IT MUST NOT TRANSMIT LOAD FROM THE ASPHALT OR CONCRETE SLAB TO THE TANK. A MINIMUM SPACE OF 3" MUST EXIST BETWEEN THE RISER OR SUMP AND THE SLAB

 (\Box) TANKS SUBJECTED TO TRAFFIC LOADS (H-20 LOADS) MUST HAVE A COVER DEPTH OF AT LEAST 18" OF BACKFILL (36" FOR 12' TANKS) PLUS 6" OF REINFORCED CONCRETE OR 9" OF ASPHALT. TANKS NOT SUBJECTED TO TRAFFIC LOADS MUST HAVE A COVER DEPTH OF AT LEAST 24" OF BACKFILL (48" FOR

-12' TANKS) OR 12" OF BACKFILL (36" FOR 12' TANKS) PLUS 4" OF REINFORCED CONCRETE OR 6" OF ASPHALT. M ALL PENETRATIONS THROUGH TANK AND ACCESS RISERS SHALL BE GAS AND WATERTIGHT. INSTALLER SHALL USE EPOXY, GROMMETS, OR OTHER APPROVED

(N) EACH CONDUIT RUN TO CONTROL PANEL SHALL BE INSTALLED WITH TWO (2) CONDUIT SEALS (0-Z/GEDNEY CAT NO EYA-125), ONE (1) EACH AT CONTROL PANEL AND SPLICE BOX.

O ACCESS RISERS AND COVERS SHALL BE GAS-TIGHT, AND WATER TESTED AFTER INSTALLATION IN ACCORDANCE WITH CONSTRUCTION SPECIFICATIONS AND IN THE PRESENCE OF DESIGNER, OWNER, OR OWNER'S AGENT


(P) A 24-HOUR WATERTIGHT TEST SHALL BE CONDUCTED ON ALL GRAYWATER SYSTEM COMPONENTS PER CONSTRUCTION SPECIFICATIONS. CONTRACTOR IS RESPONSIBLE FOR WATER TESTING THE TANKS ONCE THE TANKS INSTALLATION HAS BEEN COMPLETED AND ALLOWED TO SET OVERNIGHT. WATER TESTING SHALL BE CONDUCTED IN ACCORDANCE WITH ASTM C1227.9.2. INSTALLING CONTRACTOR SHALL BE RESPONSIBLE FOR PROVIDING CLEAN WATER FOR THE TESTING, FILLING THE TANKS, AND PUMPING THE TANKS DRY ONCE TESTING IS COMPLETE.

(Q) TANKS SHALL BE INSTALLED WITH A MINIMUM OF 12" OF COMPACTED CRUSHED STONE BEDDING. SELECT FILL SHALL BE USED IF BACKFILLING AROUND TANKS. NATIVE MATERIAL MAY BE USED IF APPROVED BY THE DESIGN ENGINEER.

(S) ALL ELECTRICAL WORK IS THE RESPONSIBILITY OF THE CONTRACTOR'S LICENSED ELECTRICIAN AND IS NOT PROVIDED BY SYSTEM ENGINEER. SYSTEM CONTROLLER, IF APPLICABLE, SHOULD BE INSTALLED IN A HEATED BUILDING WHERE AN AMBIENT TEMPERATURE RANGE OF 60 TO 90° F IS MAINTAINED. IF THE CONTROL PANEL MUST BE LOCATED OUTSIDE AND FREEZING TEMPERATURES ARE ANTICIPATED, NOTIFY MANUFACTURER SO A HEATER MAY BE INSTALLED WITHIN THE ENCLOSURE.

(T) CONTRACTOR IS RESPONSIBLE FOR INSTALLING A DEDICATED ANALOG PHONE LINE, IF APPLICABLE, TO THE CONTROL PANEL FOR THE AUTODIALER/MODEM. PHONE LINE MUST BE INSTALLED AND WORKING IN ORDER TO HAVE ANY WORK PERFORMED UNDER WARRANTY. ANY WORK PERFORMED ON THE SYSTEM WITHOUT THE INSTALLATION OF THE PHONE LINE SHALL BE AT THE SOLE EXPENSE OF THE OWNER

TANK NOTES

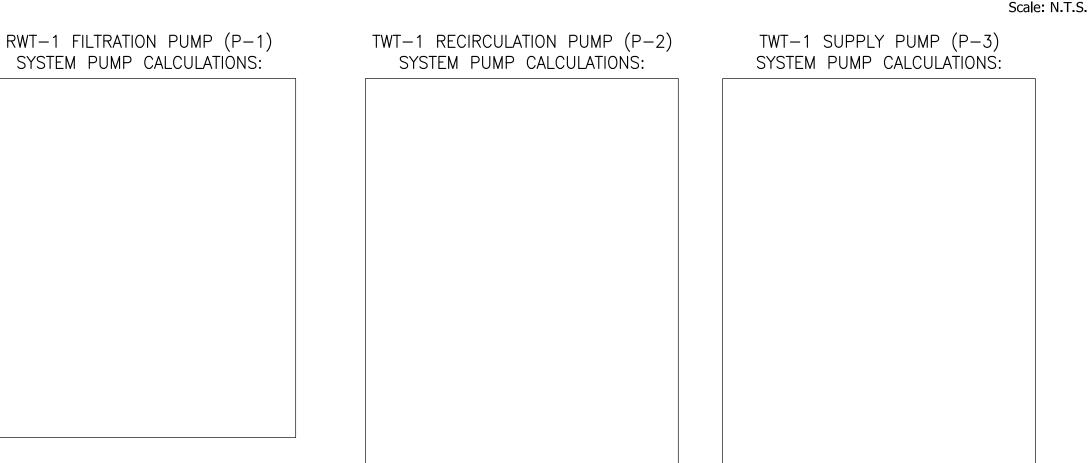

RWT-1 FILTRATION PUMP (P-1)SYSTEM PUMP SPECIFICATIONS:

STA-RITE DOMINATOR MODEL NO: 20D0M05221 28.0 GPM 62.0 TDH $1/2 \, HP$ 1 PH <u>60</u>HZ <u>230</u>V

<u>4.6</u> FL AMPS

ELEC:

TWT-1 RECIRCULATION PUMP (P-2) SYSTEM PUMP SPECIFICATIONS:


STA-RITE DOMINATOR MODEL NO: 20D0M05221 RATING: <u>28.0</u> GPM <u>37.0</u> TDH <u>1/2</u>HP <u>1</u>PH 60 HZ <u>230</u> V ELEC:

TWT-1 SUPPLY PUMP (P-3)

SYSTEM PUMP SPECIFICATIONS: STA-RITE DOMINATOR MODEL NO: 20D0M05221 <u>12.5</u> GPM <u>110.0</u> TDH <u>1/2</u> HP <u>1</u> PH ELEC: ELEC: <u>4.6</u> FL AMPS

RAIN WATER HARVESTING SYSTEM PUMP CALCULATIONS & SPECIFICATIONS Scale: N.T.S.

<u>4.6</u> FL AMPS

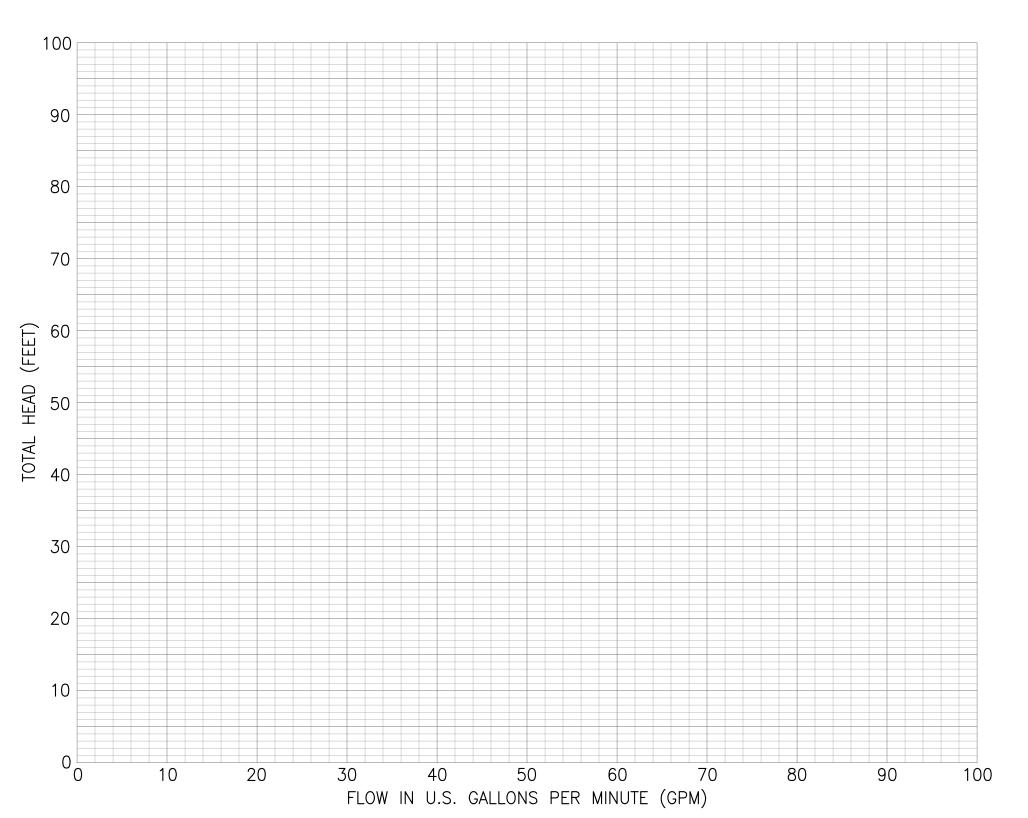

RAIN WATER HARVESTING SYSTEM PUMP CURVES

Scale: N.T.S.

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DRAWING NO. **6693** SHEET TITLE RAIN WATER

DETAILS

HARVESTING SYSTEM

-TOP MOUNTED 6 POSITION MULTIPORT WITH

AND INTEGRAL SIGHT GLASS FOR BACKWASH

-WATER/SAND DRAIN

-FIBERGLASS STRUCTURAL

N.T.S.

PER MFR

BASE PER MFR

-PAVING BY

OTHERS

2" SCH 80 PVC UNION CONNECTIONS,

CLARITY CONFIRMATION PER MFR

PRESSURE GAUGE, AUTOMATIC AIR BLEED

1. CONTRACTOR SHALL FOLLOW FILTER VESSEL MANUFACTURER'S INSTALLATION INSTRUCTIONS. FOR COMPLETE DESIGN AND PRODUCT INFORMATION CONTACT TRIDENT FILTRATION, INC. OR WATER RECYCLING SYSTEMS.

2. THE FILTER VESSEL SHOULD BE PLACED ON A LEVEL CONCRETE SLAB, VERY FIRM GROUND, OR EQUIVALENT. POSITION THE FILTER SO THAT THE PIPING CONNECTIONS, CONTROL VALVE, ARE CONVENIENT AND ACCESSIBLE FOR OPERATION AND SERVICE.

3. LOADING THE FILTER VESSEL WITH MEDIA SHALL BE PERFORMED IN ACCORDANCE WITH THE MFR

4. ALL CONNECTIONS TO FILTER VESSEL SHALL BE WATERTIGHT PER MFR. 5. THE FILTER VESSEL OPERATES UNDER HIGH PRESSURE, PRIOR TO SERVICING FILTER VESSEL, TURN PUMP OFF TO PREVENT DAMAGE TO THE SYSTEM.

S-1: SAND FILTER VESSEL 1 DETAIL

8" THICK H-20 TRAFFIC SLAB-—ALUMINUM LID FOR LIGHT TRAFFIC AREAS WITH LIFTING HANDLE PER MFR. INSPECTION OPENING CAN RAISED TO TOP 2500 PSI CLASS A CONCRETE OF GRADE WITH EXTENSION PIECE PER MFR (NOT SHOWN) WITH 3 #4 REBAR EXTEND 12" MIN. BËYOND TANK EACH WAY - EBW, INC. 30" SAFE-LITE BOLT DOWN LID MODEL 781-430-12 GRADE OR -CAST IN SLAB. H-20 GAS TIGHT PAVING BY MANHOLE COVER OPTHERS FS=161.15 ► PEA GRAVEL (TYP.) -GROUT SEAL (TYP.) 6"ø SDR 35 RAIN WATER → INLET FROM SD, INV=157.64 ∠ JM EAGLE PVC SDR 6"ø SCH 40 PVC PIPE-35 8"Ø TO 6"Ø PIPE REDUCER, OR EQUAL TO 6"ø SDR 35 ADAPTOR ← 6"ø SDR 35 FILTERED SPEARS 12"x6" SCH 40 PVC REDUCER BUSHING RAIN WATER OUTLET MODEL 437-666, OR EQUAL TO RWT-1, INV=156.14 -SPEARS 12"x6" SCH 40 PVC REDUCER BUSHING MODEL 437-666 W/ SCH 40 PVC 90° ELBOW MODEL 406-060 OR EQUAL VF-1: VORTEX RAINWATER FILTER → 1, J.R. SMITH MFG. CO. WISY → 6"ø SDR 35 STORM WATER MODEL WF3011 WITH ALUMINUM OVERFLOW TO SD, INV=154.48 LID FOR LIGHT TRAFFIC AREAS 28"—— 6"ø SCH 40 PVC PIPE TO 6"ø SDR 35 ADAPTOR 6" MIN. 3/8" PEA GRAVEL -OR CRUSHED STONE BASE PER MFR SPECIFICATIONS FRANKLIN FUELING SYSTEMS P.O. BOX 3237 MONTGOMERY, AL 36109 TEL: 334.227.8520 FAX: 334.272.7396 (EBW, INC.) 3760 MARSH ROAD MÁDISON, WI 53718 TEL: 562.480.0167 WWW.JRSMITH.COM

1. CONTRACTOR SHALL FOLLOW VORTEX FILTER MANUFACTURER'S INSTALLATION INSTRUCTIONS. FOR COMPLETE DESIGN AND PRODUCT INFORMATION CONTACT J.R. SMITH MFG. CO. OR FRANKLIN FUELING SYSTEMS (EBW. INC.).

2. IF VORTEX FILTER IS LOCATED IN NON TRAFFIC AREA, CONTRACTOR MAY SUBSTITUTE ALTERNATIVE NON-TRAFFIC RATED INSTALLATION WITH ENGINEER APPROVED EQUAL.

VF-1: VORTEX RAIN WATER FILTER 1 DETAIL

-MICROSEPTEC HIBLOW HP-120 ABOVE GROUND AIR COMPRESSOR, OR EQUAL WITH LOW AIR PRESSURE ASSEMBLY WIRED INTO CONTROL PANEL MICROSEPTEC, INC. 5150 JEFFERSON CHEMICAL ROAD CONROE, TX 77301 -1-1/4"ø SCH 80 PVC / 1 AIR LINE TO RWT-1 W-6WWW.CONTAINMENTSOLUTIONS.COM 1"ø SCH 80 PVC— PAVING BY ELECTRICAL LINE TO CONTROL PANEL 4 12.25" 7.5"

1. CONTRACTOR SHALL FOLLOW AIR COMPRESSOR MANUFACTURER'S INSTALLATION INSTRUCTIONS. FOR

COMPLETE DESIGN AND PRODUCT INFORMATION CONTACT MICROSEPTEC. 2. CONTRACTOR TO LOCATE IN SHADED AREA AWAY OUT OF DIRECT SUBLIGHT OR PROVIDE SHADE COVER. COMPRESSORS SHOULD BE LOCATED IN A WELL-VENTILATED SHADY PLACE. AN INDOOR LOCATION LIKE A SHED OR GARAGE IS IDEAL.

3. COMPRESSORS MUST BE ELEVATED OFF THE GROUND SO THAT SURFACE WATER CANNOT ENTER THE ELECTRICAL TERMINALS WITHIN THE COMPRESSOR.


4. COMPRESSORS SHOULD BE LOCATED AS CLOSE TO THE TANK AS POSSIBLE. DO NOT EXCEED 50' DISTANCE FROM TANK.

5. 1" SCH 80 PVC PIPE IS REQUIRED FOR PLUMBING THE COMPRESSOR(S) TO THE CISTERN; ONE PIPE PER COMPRESSOR. THE PIPE MUST FALL TOWARD THE TANK WITH NO LOW POINTS. COMPRESSORS MUST BE LOCATED AT THE SAME ELEVATION OR HIGHER THAN TOP OF CISTERN.

MICROSEPTEC AIR COMPRESSOR DETAIL

SCALE: N.T.S.

SCALE: N.T.S.

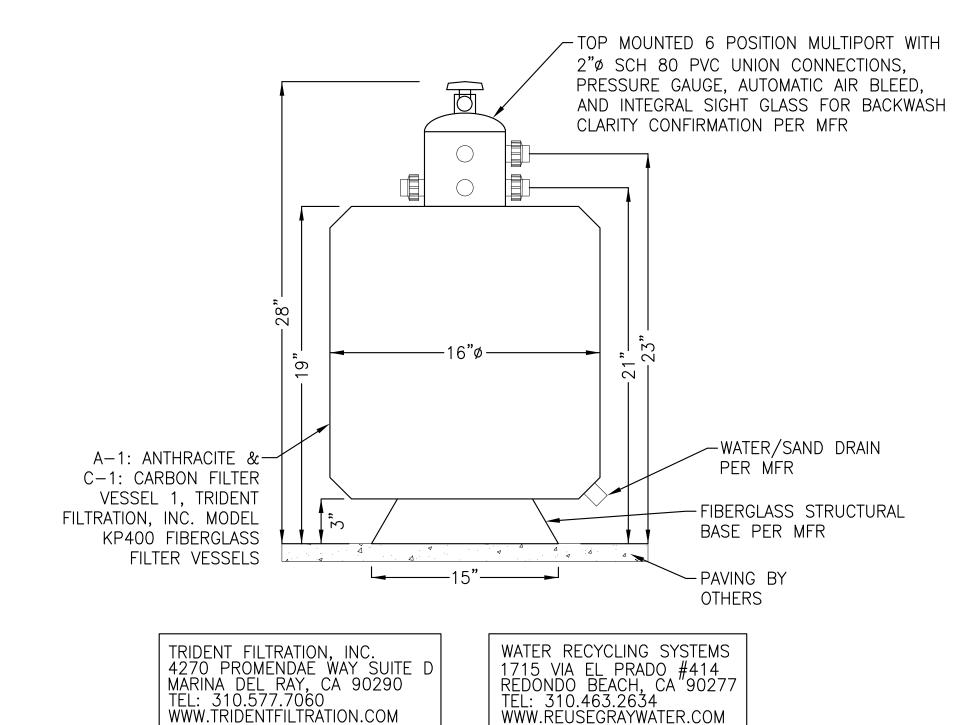

1. CONTRACTOR SHALL FOLLOW FILTER VESSEL MANUFACTURER'S INSTALLATION INSTRUCTIONS. FOR COMPLETE DESIGN AND PRODUCT INFORMATION CONTACT TRIDENT FILTRATION, INC. OR WATER


RECYCLING SYSTEMS. 2. THE FILTER VESSEL SHOULD BE PLACED ON A LEVEL CONCRETE SLAB, VERY FIRM GROUND, OR EQUIVALENT. POSITION THE FILTER SO THAT THE PIPING CONNECTIONS, CONTROL VALVE, ARE CONVENIENT AND ACCESSIBLE FOR OPERATION AND SERVICE.

3. LOADING THE FILTER VESSEL WITH MEDIA SHALL BE PERFORMED IN ACCORDANCE WITH THE MFR

SPECIFICATIONS. 4. ALL CONNECTIONS TO FILTER VESSEL SHALL BE WATERTIGHT PER MFR.

5. THE FILTER VESSEL OPERATES UNDER HIGH PRESSURE, PRIOR TO SERVICING FILTER VESSEL, TURN PUMP OFF TO PREVENT DAMAGE TO THE SYSTEM.

A-1 AND C-1: ANTHRACITE AND CARBON FILTER VESSEL 1 DETAIL

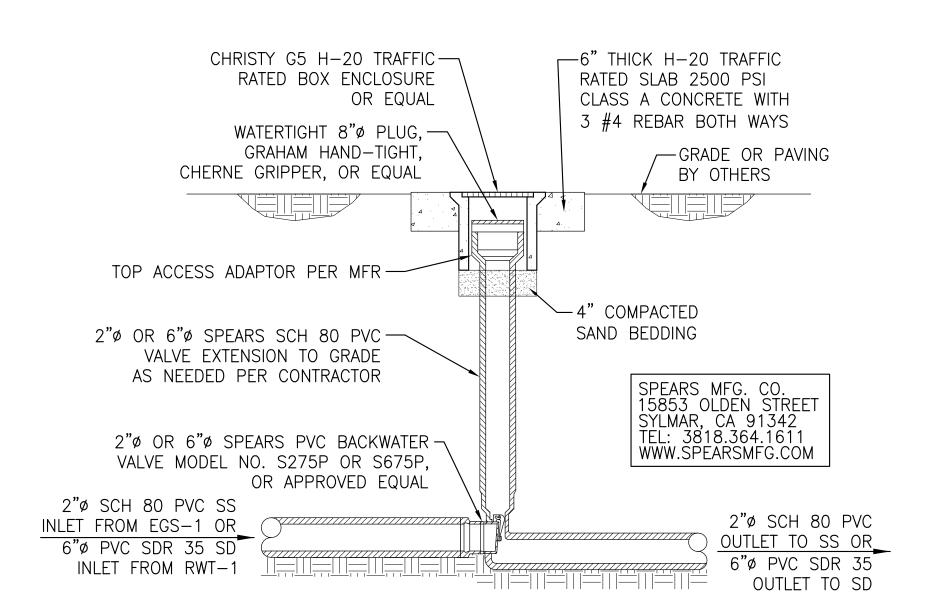


1. CONTRACTOR SHALL FOLLOW BACKWATER MANUFACTURER'S INSTALLATION INSTRUCTIONS. FOR COMPLETE DESIGN AND PRODUCT INFORMATION CONTACT SPEARS MFG. CO.

2. BACKWATER VALVES OFFER PROTECTION AGAINST BACKWATER SURGES. BACKFLOW IS PREVENTED WHEN VALVE IS NOT OBSTRUCTED BY DEBRIS OR SLUDGE. USE FOR GRAVITY FLOW ONLY, NOT FOR PRESSURIZED APPLICATIONS.

3. IF BACKWATER VALVES ARE LOCATED IN NON TRAFFIC AREA, CONTRACTOR MAY SUBSTITUTE ALTERNATIVE NON-TRAFFIC RATED INSTALLATION WITH ENGINEER APPROVED EQUAL BWV: BACKWATER VALVE DETAIL

PROPRIETARY MANUFACTURER NOTES: ALL PROPRIETARY SPECIFICATIONS ARE "OR EQUAL" SUBJECT TO WRITTEN APPROVAL OF SUBMITTAL BY ENGINEER.

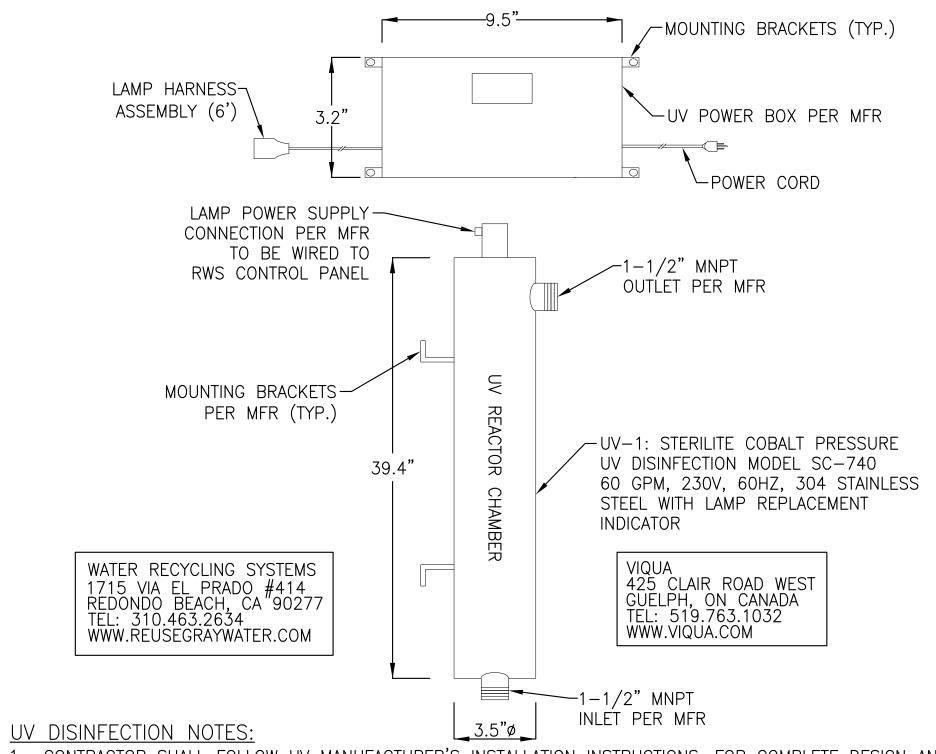

1. CONTRACTOR SHALL FOLLOW UV MANUFACTURER'S INSTALLATION INSTRUCTIONS. FOR COMPLETE DESIGN AND PRODUCT INFORMATION CONTACT VIQUA. OR WATER RECYCLING SYSTEMS.

2. UV DISINFECTION UNIT NEEDS TO BE MAINTAINED. CHANGE YOUR LAMP ON A YEARLY BASIS OR PER MANUFACTURER'S RECOMMENDATIONS TO INSURE THAT THE QUARTZ SLEEVE IS CLEAN ON A REGULAR BASIS.

3. THE ELECTRONICS HAVE BEEN DESIGNED TO WORK WITH STANDARD POWER SUPPLIES. SINCE THE UNIT IS SUSCEPTIBLE TO POWER FLUCTUATIONS, WE RECOMMEND THAT THE SYSTEM BE KEPT OFF ANY LINES WHERE THERE ARE SURGES. THIS INCLUDES PUMPS OR MOTORS. IF THERE ARE FLUCTUATIONS, PLEASE USE A SURGE SUPPRESSOR. SEE MANUFACTURER'S RECOMMENDATIONS


4. WHEN INSTALLING, REMEMBER THAT YOU WILL NEED TO BE ABLE TO REMOVE LAMPS AND QUARTZ AS PART OF MAINTENANCE SCHEDULE. ALLOW YOURSELF ENOUGH ROOM TO ACCOMPLISH THESE TASKS. UNIT IS DESIGNED TO BE MOUNTED VERTICALLY AND SECURED TO WALL OR SOLID SURFACE. CONTRACTOR SHALL VERIFY UV UNIT HAS ENOUGH CLEARANCE PRIOR TO COMMENCEMENT OF CONSTRUCTION

UV-1: UV DISINFECTION 1 DETAIL

N.T.S.

SCALE: N.T.S.

SCALE: N.T.S.

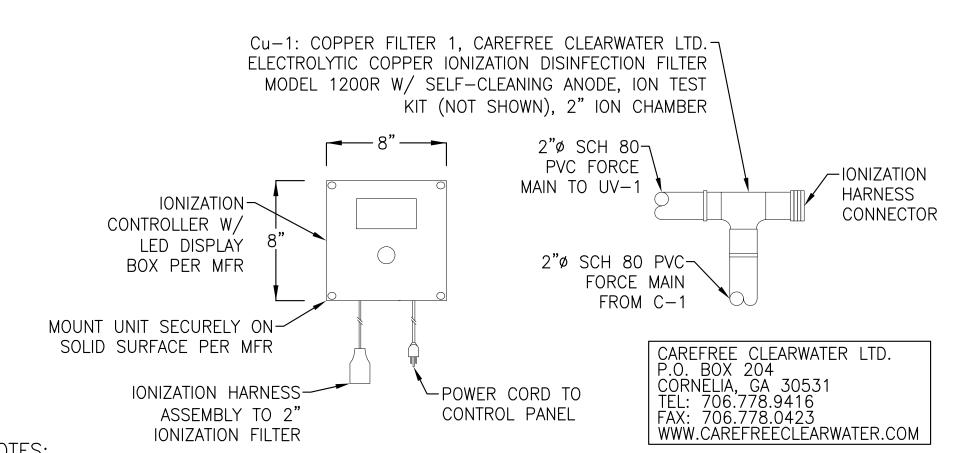

CONTRACTOR SHALL FOLLOW MANUFACTURER'S INSTALLATION INSTRUCTIONS. FOR COMPLETE DESIGN AND PRODUCT INFORMATION CONTACT CAREFREE CLEARWATER LTD. OR WATER RECYCLING SYSTEMS 2. IONIZER UNIT IS PROVIDED NEMA 4X AND UL 508-4X RATED WATERPROOF ENCLOSURE, GASKET SEALED CLEAR

ACRYLIC VIEW COVER, TAMPER PROOF. 3. IONIZER UNIT REQUIRES PERIODIC OXIDIZING AND MAINTAINING NORMAL WATER BALANCE PER MANUFACTURER

4. Cu-1 UNIT IS PROVIDED AS PART OF THE PACKAGE FOR THE WATER RECYCLING RAIN WATER HARVESTING SYSTEM.

Cu-1: COPPER FILTER 1 DETAIL

SCALE: N.T.S.

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ARCHITECT'S PROJECT NO.

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SUBMITTED BY:	_	

Miriam Mulder, Architecture Services Manager CITY OF SANTA MONICA

DEPARTMENT OF PUBLIC WORKS

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NO. DATE BY DESCRIPTION REVISIONS

PRELIMINARY-NOT FOR CONSTRUCTION

06/12/2012 DRAWING NO. 6693

SHEET TITLE RAIN WATER HARVESTING SYSTEM **DETAILS**